

TOWNZEN & ASSOCIATES
PLAN APPROVAL

The plans submitted for review are approved in accordance with local state applicable standards. This approval does not relieve the applicant of the responsibility of compliance with the applicable codes.

Approved as submitted.
02/10/2020



Konrad Weber

- 1) CONTRACTOR TO FIELD VERIFY ALL EXISTING CONDITIONS AND THE CONSTRUCTION DOCUMENTS PRIOR TO COMMENCING CONSTRUCTION. CONTRACTOR TO NOTIFY DESIGNER IMMEDIATELY OF ANY DISCREPANCIES, ERRORS OR OMISSIONS.
- 2) ALL CONSTRUCTION WORK SHALL BE DONE IN COMPLIANCE WITH THE LATEST EDITION OF THE APPLICABLE BUILDING CODE AS AMENDED BY THE STATE AND ALL OTHER STATE AND LOCAL REQUIREMENTS THAT APPLY.
- 3) CONTRACTOR SHALL ASSUME SOLE RESPONSIBILITY FOR SAFETY OF ALL PERSONS ON OR ABOUT THE CONSTRUCTION SITE IN ACCORDANCE WITH APPLICABLE LAWS AND CODES. GUARD AGAINST ALL HAZARDS IN ACCORDANCE WITH THE SAFETY PROVISIONS OF THE LATEST MANUAL OF ACCIDENT PREVENTION PUBLISHED BY THE ASSOCIATED GENERAL CONTRACTORS OF AMERICA.
- 4) CONTRACTOR TO PROTECT PROPERTY FROM DAMAGE DURING CONSTRUCTION.
- 5) CONTRACTOR TO BE HELD RESPONSIBLE FOR REPLACEMENT OF DAMAGED MATERIALS OR LOSS OF MATERIALS DURING CONSTRUCTION.
- 6) CONTRACTOR TO PROTECT ALL EXPOSED AREAS WITH TEMPORARY COVER TO PREVENT WATER INFILTRATION INTO THE BUILDING INTERIOR OR WIND DAMAGE DURING CONSTRUCTION.
- 7) DO NOT SCALE DRAWINGS. USE DIMENSIONS SHOWN. IN NO CASE SHALL WORKING DIMENSIONS BE SCALED FROM DRAWINGS. IT SHALL BE THE CONTRACTOR'S RESPONSIBILITY TO CROSS CHECK DETAILS AND DIMENSIONS SHOWN ON THE ARCHITECTURAL DRAWINGS WITH RELATED REQUIREMENTS ON THE CIVIL, STRUCTURAL, MECHANICAL, ELECTRICAL, PLUMBING AND OTHER DRAWINGS AS APPLICABLE. NOTIFY THE DESIGNER OF ANY DISCREPANCIES, ERRORS OR OMISSIONS BEFORE COMMENCING WORK.
- 8) CONDITIONS AND DETAILS MARKED "TYPICAL" SHALL APPLY IN ALL CASES UNLESS SPECIFICALLY INDICATED OTHERWISE. TYPICAL DETAILS NOT REFERENCED ON DRAWINGS APPLY UNLESS NOTED OTHERWISE BY SPECIFIC NOTES AND DETAILS. WHERE NO SPECIFIC DETAIL IS SHOWN, THE CONSTRUCTION SHALL BE IDENTICAL OR SIMILAR TO THAT INDICATED FOR THE TYPICAL CONSTRUCTION ON THE PROJECT.
- 9) WHERE NO SPECIFIC STANDARDS ARE APPLIED TO A MATERIAL OR METHOD OF CONSTRUCTION TO BE USED IN THE WORK, ALL SUCH MATERIALS AND METHODS ARE TO MAINTAIN THE STANDARDS OF THE INDUSTRY.
- 10) MATERIALS, EQUIPMENT, ETC., NOT INDICATED ON DRAWINGS OR SPECIFIED HEREIN BUT REQUIRED FOR THE SUCCESSFUL AND EFFICIENT COMPLETION OF THE INSTALLATION SHALL BE HELD TO BE IMPLIED AND SHALL BE FURNISHED AND INSTALLED BY THE CONTRACTOR FOR NO ADDITIONAL COST.
- 11) ERRORS OR OMISSIONS IN ANY SCHEDULE OR DRAWING DO NOT RELIEVE THE CONTRACTOR FROM RESPONSIBILITY FOR THE WORK INTENDED IN THE DRAWINGS OR THE SPECIFICATIONS.
- 12) COORDINATE/ VERIFY ALL INTERIOR FINISHES WITH OWNER REPRESENTATIVE.
- 13) CONSTRUCTION MATERIALS SHALL BE SPREAD OUT IF PLACED ON FRAMED FLOORS OR ROOF. LOAD SHALL NOT EXCEED THE DESIGN LIVE LOAD PER SQUARE FOOT AT ANY TIME.
- 14) CONTRACTOR TO BE RESPONSIBLE FOR ALL TEMPORARY BRACING REQUIRED DURING CONSTRUCTION.
- 15) ALL EXTERIOR SURFACES INCLUDING GRADE, DECKS, PORCHES AND EXTERIOR PAVING TO SLOPE AWAY FROM BUILDING AT 1/4" PER FOOT MIN. UNLESS NOTED OTHERWISE.
- 16) MAINTAIN 6 INCHES CLEAR MINIMUM BETWEEN SIDING AND FINISHED GRADE.
- 17) CONNECT ALL DOWNSPOUTS AND FOUNDATION DRAINS TO EXISTING STORM SYSTEM OR OTHER APPROVED TERMINUS.
- 18) ALL EXTERIOR EXPOSED WORK TO BE INSTALLED IN WEATHER TIGHT MANNER; FLASH, CAULK AND PROVIDE WEATHER BARRIER MATERIALS IN A MANNER & SEQUENCE AS REQUIRED FOR WATERTIGHT CONSTRUCTION.
- 19) ESTABLISH AND VERIFY ALL OPENINGS AND INSERTS FOR ARCHITECTURAL, MECHANICAL, ELECTRICAL, AND PLUMBING WITH APPROPRIATE TRADES, DRAWINGS, AND SUBCONTRACTORS PRIOR TO CONSTRUCTION.
- 20) ALL PRODUCTS TO BE INSTALLED PER LATEST EDITION OF THE MANUFACTURER'S INSTALLATION RECOMMENDATIONS AND PUBLISHED INDUSTRY STANDARDS.
- 21) ALL DIMENSIONS ARE TO EDGE OF STUD UNLESS NOTED OTHERWISE.
- 22) ALL DOORS ADJACENT TO WALLS ARE 4" FROM FACE OF JAMB TO FACE OF WALL UNLESS NOTED OTHERWISE.
- 23) SEE WALL TYPES AND CONSTRUCTION ASSEMBLY DETAILS FOR CONFIGURATION OF WALL COMPONENTS.
- 24) STRUCTURAL, FIRE RESISTIVE AND SOUND RESISTIVE INTEGRITY IS TO BE MAINTAINED AT PENETRATIONS FOR ELECTRICAL, MECHANICAL, PLUMBING AND CONDUITS, PIPES AND SIMILAR SYSTEMS AND IS TO BE IN ACCORDANCE WITH THE REQUIREMENTS OF GOVERNING CODES AND AUTHORITIES.
- 25) PROVIDE SEALANT AT ALL OPENINGS MADE IN WALL AND FLOOR SURFACES AND FRAMING FOR SUPPLY AND DRAIN LINES; PROVIDE SEALANT, AIR TIGHT, AROUND ELECTRICAL OUTLETS AND JUNCTION BOXES.
- 26) NAILING, FRAMING AND FASTENING TO COMPLY WITH STRUCTURAL REQUIREMENTS, CODE STANDARDS, AND FIRE RATED ASSEMBLY REQUIREMENTS AS APPLICABLE.
- 27) DO NOT NOTCH OR DRILL JOISTS, BEAMS, OR LOAD BEARING STUDS WITHOUT THE PRIOR APPROVAL OF THE DESIGNER AND STRUCTURAL ENGINEER.
- 28) ALL WOOD EXPOSED TO WEATHER OR IN CONTACT WITH CONCRETE TO BE PRESSURE TREATED.
- 29) ALL EXPOSED METAL CONNECTIONS, FASTENERS, COVERS AND RELATED APPURTENANCES TO BE NON-CORROSIVE.
- 30) PROVIDE PROTECTION FOR ALL CABLE AND ELECTRICAL WIRING WITHIN WALL CAVITY.
- 31) PROVIDE AND INSTALL BLOCKING, BRACING AND STRAPPING AS REQUIRED FOR CABINETS, TOILET ACCESSORIES, HVAC, PLUMBING, ELECTRICAL AND ANY OTHER FIXTURES THAT REQUIRE SUPPORT BRACING.
- 32) PROVIDE PRODUCTS AND INSULATION IN COMPLIANCE STATE ENERGY CODE AND LOCAL JURISDICTION REQUIREMENTS.
- 33) PROVIDE ACCOUSTIC INSULATION AT ALL BATHROOM WALLS.
- 34) ALL INSULATION SHALL HAVE A MAXIMUM FLAME SPREAD OF 25 AND A SMOKE RATING OF 450.
- 35) ALL GLAZING IN HAZARDOUS LOCATIONS, INCLUDING BUT NOT LIMITED TO WITHIN OPERABLE DOORS OR WITHIN 24 INCHES OF OPERABLE DOORS, TO BE APPROVED SAFETY GLAZING MATERIALS PER THE LATEST CODE REQUIREMENTS.
- 36) TREAT ALL ENDS OF CUT PRESSURE TREATED WOOD.
- 37) CONTRACTOR TO PROVIDE ISOLATION AT ALL DIS-SIMILAR MATERIALS TO PREVENT GALVANIC ACTION.
- 38) SET WATER HEATER IN PAN, PLUMB TO EXTERIOR WALL AND PROVIDE SEIZMIC STRAPPING AS REQ'D. IF PROVIDED WITHIN GARAGE INSTALL 18" A.F.F. & PROVIDE PROTECTIVE BOLLARD EMBEDDED IN SLAB.
- 39) PROVIDE 18"x24" MIN. CRAWL SPACE ACCESS AS APPLICABLE.
- 40) PROVIDE CRAWL SPACE VENTILATION AT A RATIO OF 1/150 PER CODE.
- 41) PROVIDE 22"x 30" MIN. ATTIC ACCESS LOCATED IN A HALLWAY OR OTHER READILY ACCESSIBLE LOCATION. 30" MIN. UNOBSTRUCTED HEADROOM SHALL BE PROVIDED ABOVE THE ACCESS OPENING.
- 42) PROVIDE ATTIC VENTILATION AT RATIO OF 1/150 OR AS OTHERWISE ALLOWED BY CODE.

A.F.F.	ABOVE FINISHED FLOOR	F.O.S.	FACE OF STUD	SC	SOLID CORE
ALT.	ALTERNATE	FT.	FEET	SF	STORE FRONT
A.P.N.	ASSESSOR'S PARCEL NUMBER	HC	HOLLOW CORE	SIM.	SIMILAR
BD.	BOARD	HT.	HEIGHT	S.O.G.	SLAB ON GRADE
BLDG.	BUILDING	G.L.B.	GLU-LAMINATED BEAM	STRUCT.	STRUCTURE / STRUCTURAL
BLK.	BLOCK	MANUF.	MANUFACTURER	ST. VRN.	STAIN AND VARNISH
BLKG.	BLOCKING	MAX.	MAXIMUM	SQ.	SQUARE
B.W.P.	BRACE WALL PANEL	MIN.	MINIMUM	T.O.	TOP OF
CL	CENTERLINE	N/A	NOT APPLICABLE	T.O.P.	TOP OF PLATE
COL.	COLUMN	N.T.S.	NOT TO SCALE	TYP.	TYPICAL
CONC.	CONCRETE	NUM.	NUMBER	UBC	UNIFORM BUILDING CODE
CONT.	CONTINUOUS	O.C.	ON CENTER.	U.N.O.	UNLESS NOTED OTHERWISE
CLR.	CLEAR	P	PLATE	U.O.N.	UNLESS OTHERWISE NOTED
DIA.	DIAMETER	PL	PLATE	V.F.Y.	VERIFY
DBL.	DOUBLE	PNL	PANEL	W/	WITH
EA.	EACH	PSF	POUNDS PER SQUARE FOOT	WIN.	WINDOW
EGRES.	EGRESS	PT	PRE-TREATED	@	AT
EL.	ELEVATION	REQ.	REQUIRED	Ø	DIAMETER
EQ.	EQUAL				
E.W.	EACH WAY				
F.O.C.	FACE OF CONCRETE				
F.O.F.	FACE OF FINISH				



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INFORMATION:

PLAN NUMBER:
190820

DRAWN FOR:

REVISION	DATE

DWG BY: **N Sampson**

CHK BY:

DATE: **08/20/2019**

FILE NAME: **Lawffer**

SHEET NUMBER

A0.1



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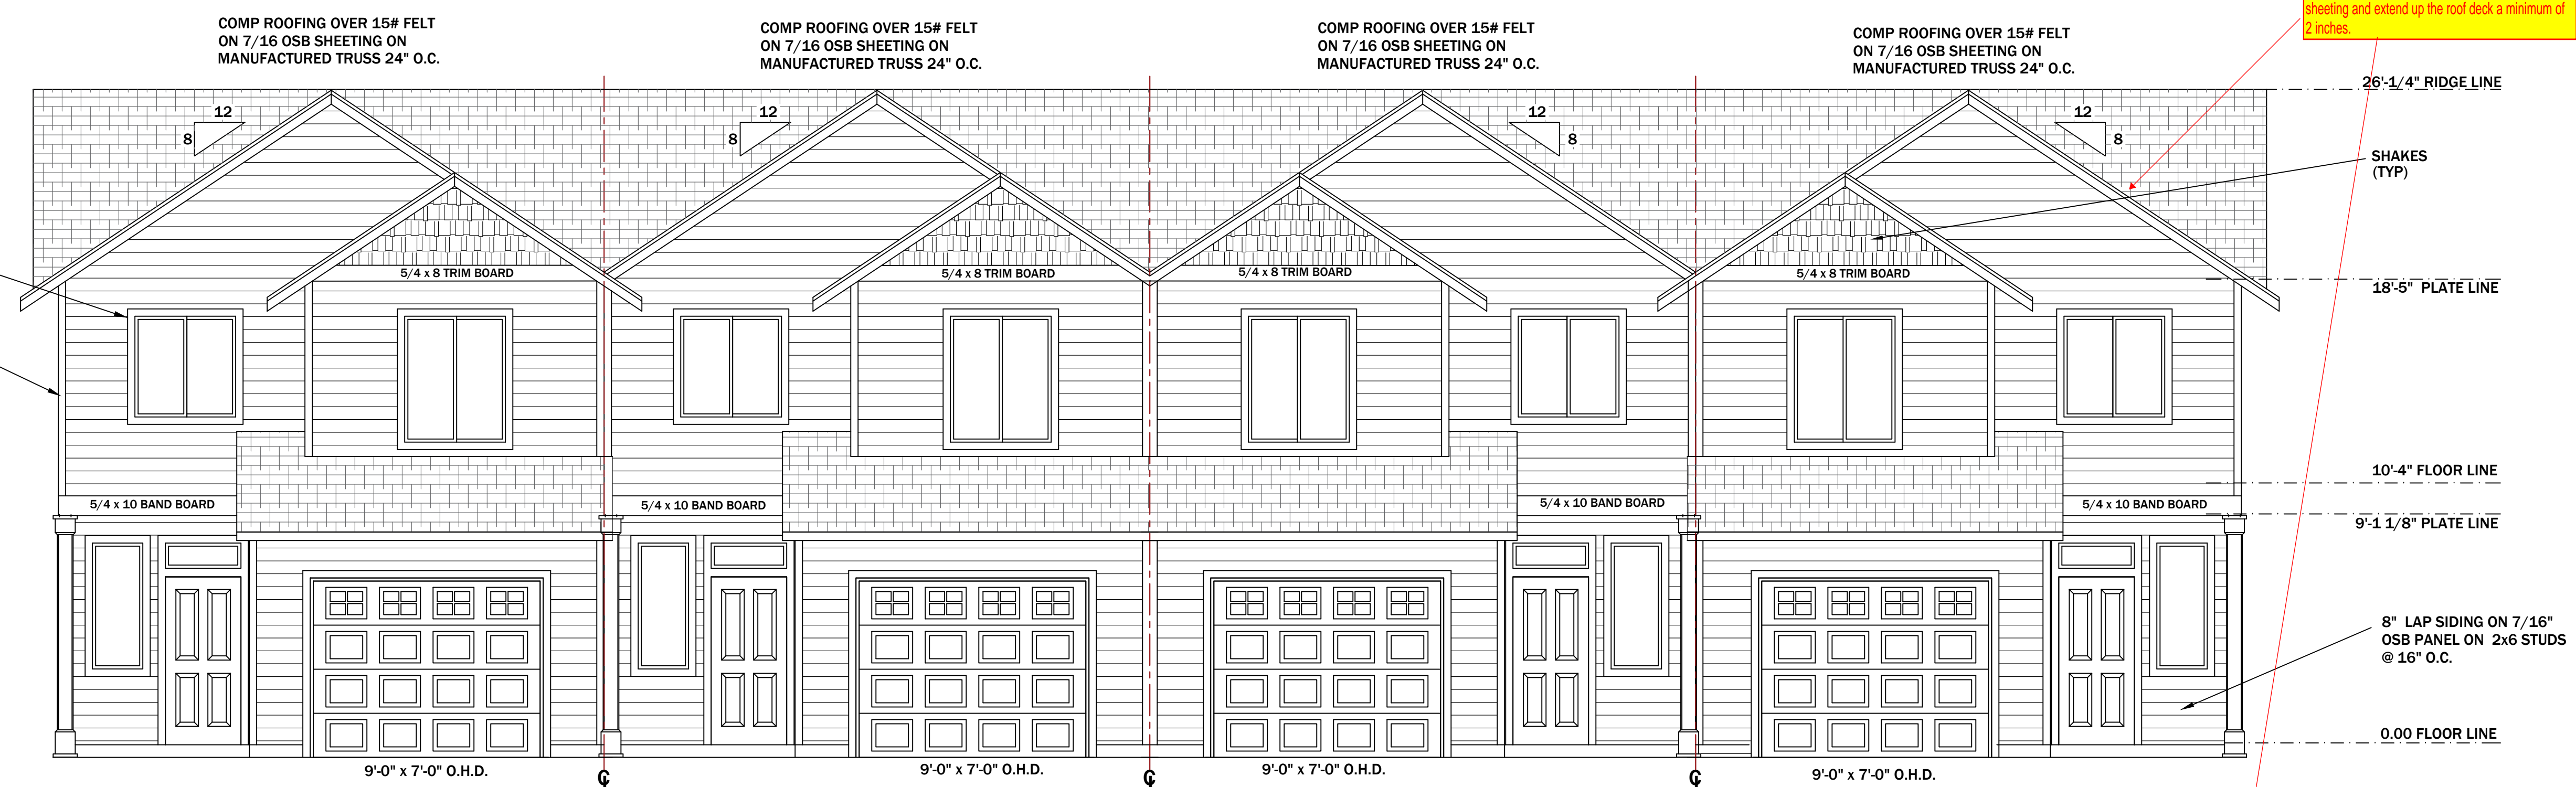
CHK BY:

DATE: **08/20/2019**

FILE NAME: **Lawffer**

SHEET NUMBER

A1.0



R905.2 8.5 DRIP EDGE a drip edge shall be provided at eaves and gables of shingle roofs. Drip edge shall extend a minimum of 0.25\"/>

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Konrad Weber

MAIN FLOOR: 628 SQ. FT.
UPPER FLOOR: 816 SQ. FT.
TOTAL: 1444 SQ. FT.
GARAGE 283 SQ. FT.
FRONT PORCH: 50 SQ. FT.

MAIN FLOOR: 618 SQ. FT.
UPPER FLOOR: 802 SQ. FT.
TOTAL: 1420 SQ. FT.
GARAGE 280 SQ. FT.
FRONT PORCH: 46 SQ. FT.


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TOTAL: 1444 SQ. FT.
GARAGE 283 SQ. FT.
FRONT PORCH: 50 SQ. FT.

FRONT ELEVATION

1/4"=1'-0"

HOUSE NUMBERS TO BE POSTED ON FRONT OF HOUSE & BE CLEARLY VISIBLE FROM STREET

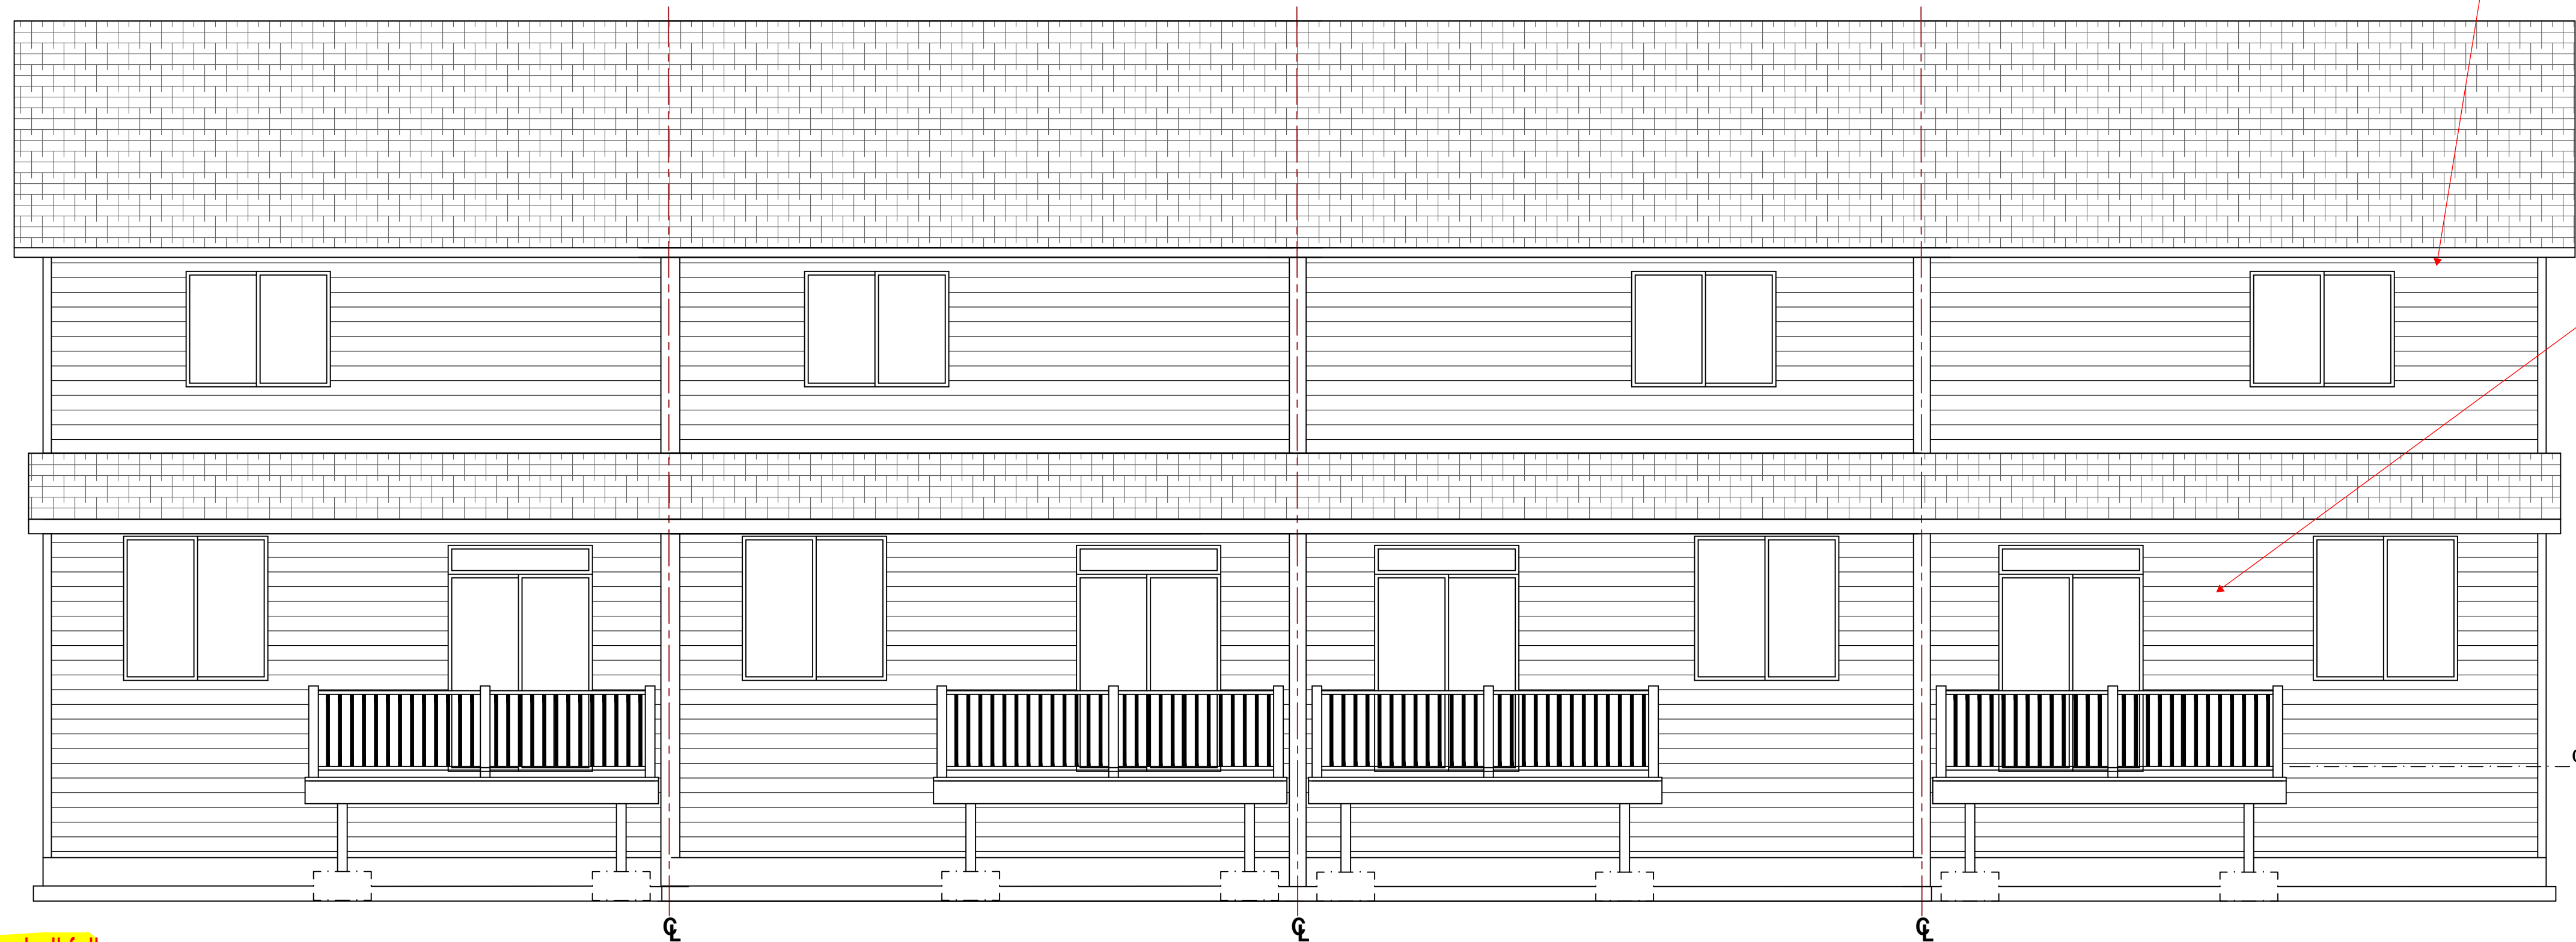

R703.1 Exterior walls shall provide the building with a weather resistant exterior wall envelope. The exterior wall envelope shall include flashing as described in Section R703.4

R401.3 Drainage. The grade shall fall a minimum of 6 inches in the first 10 feet.

REAR ELEVATION

SCALE: 1/4" = 1'-0"



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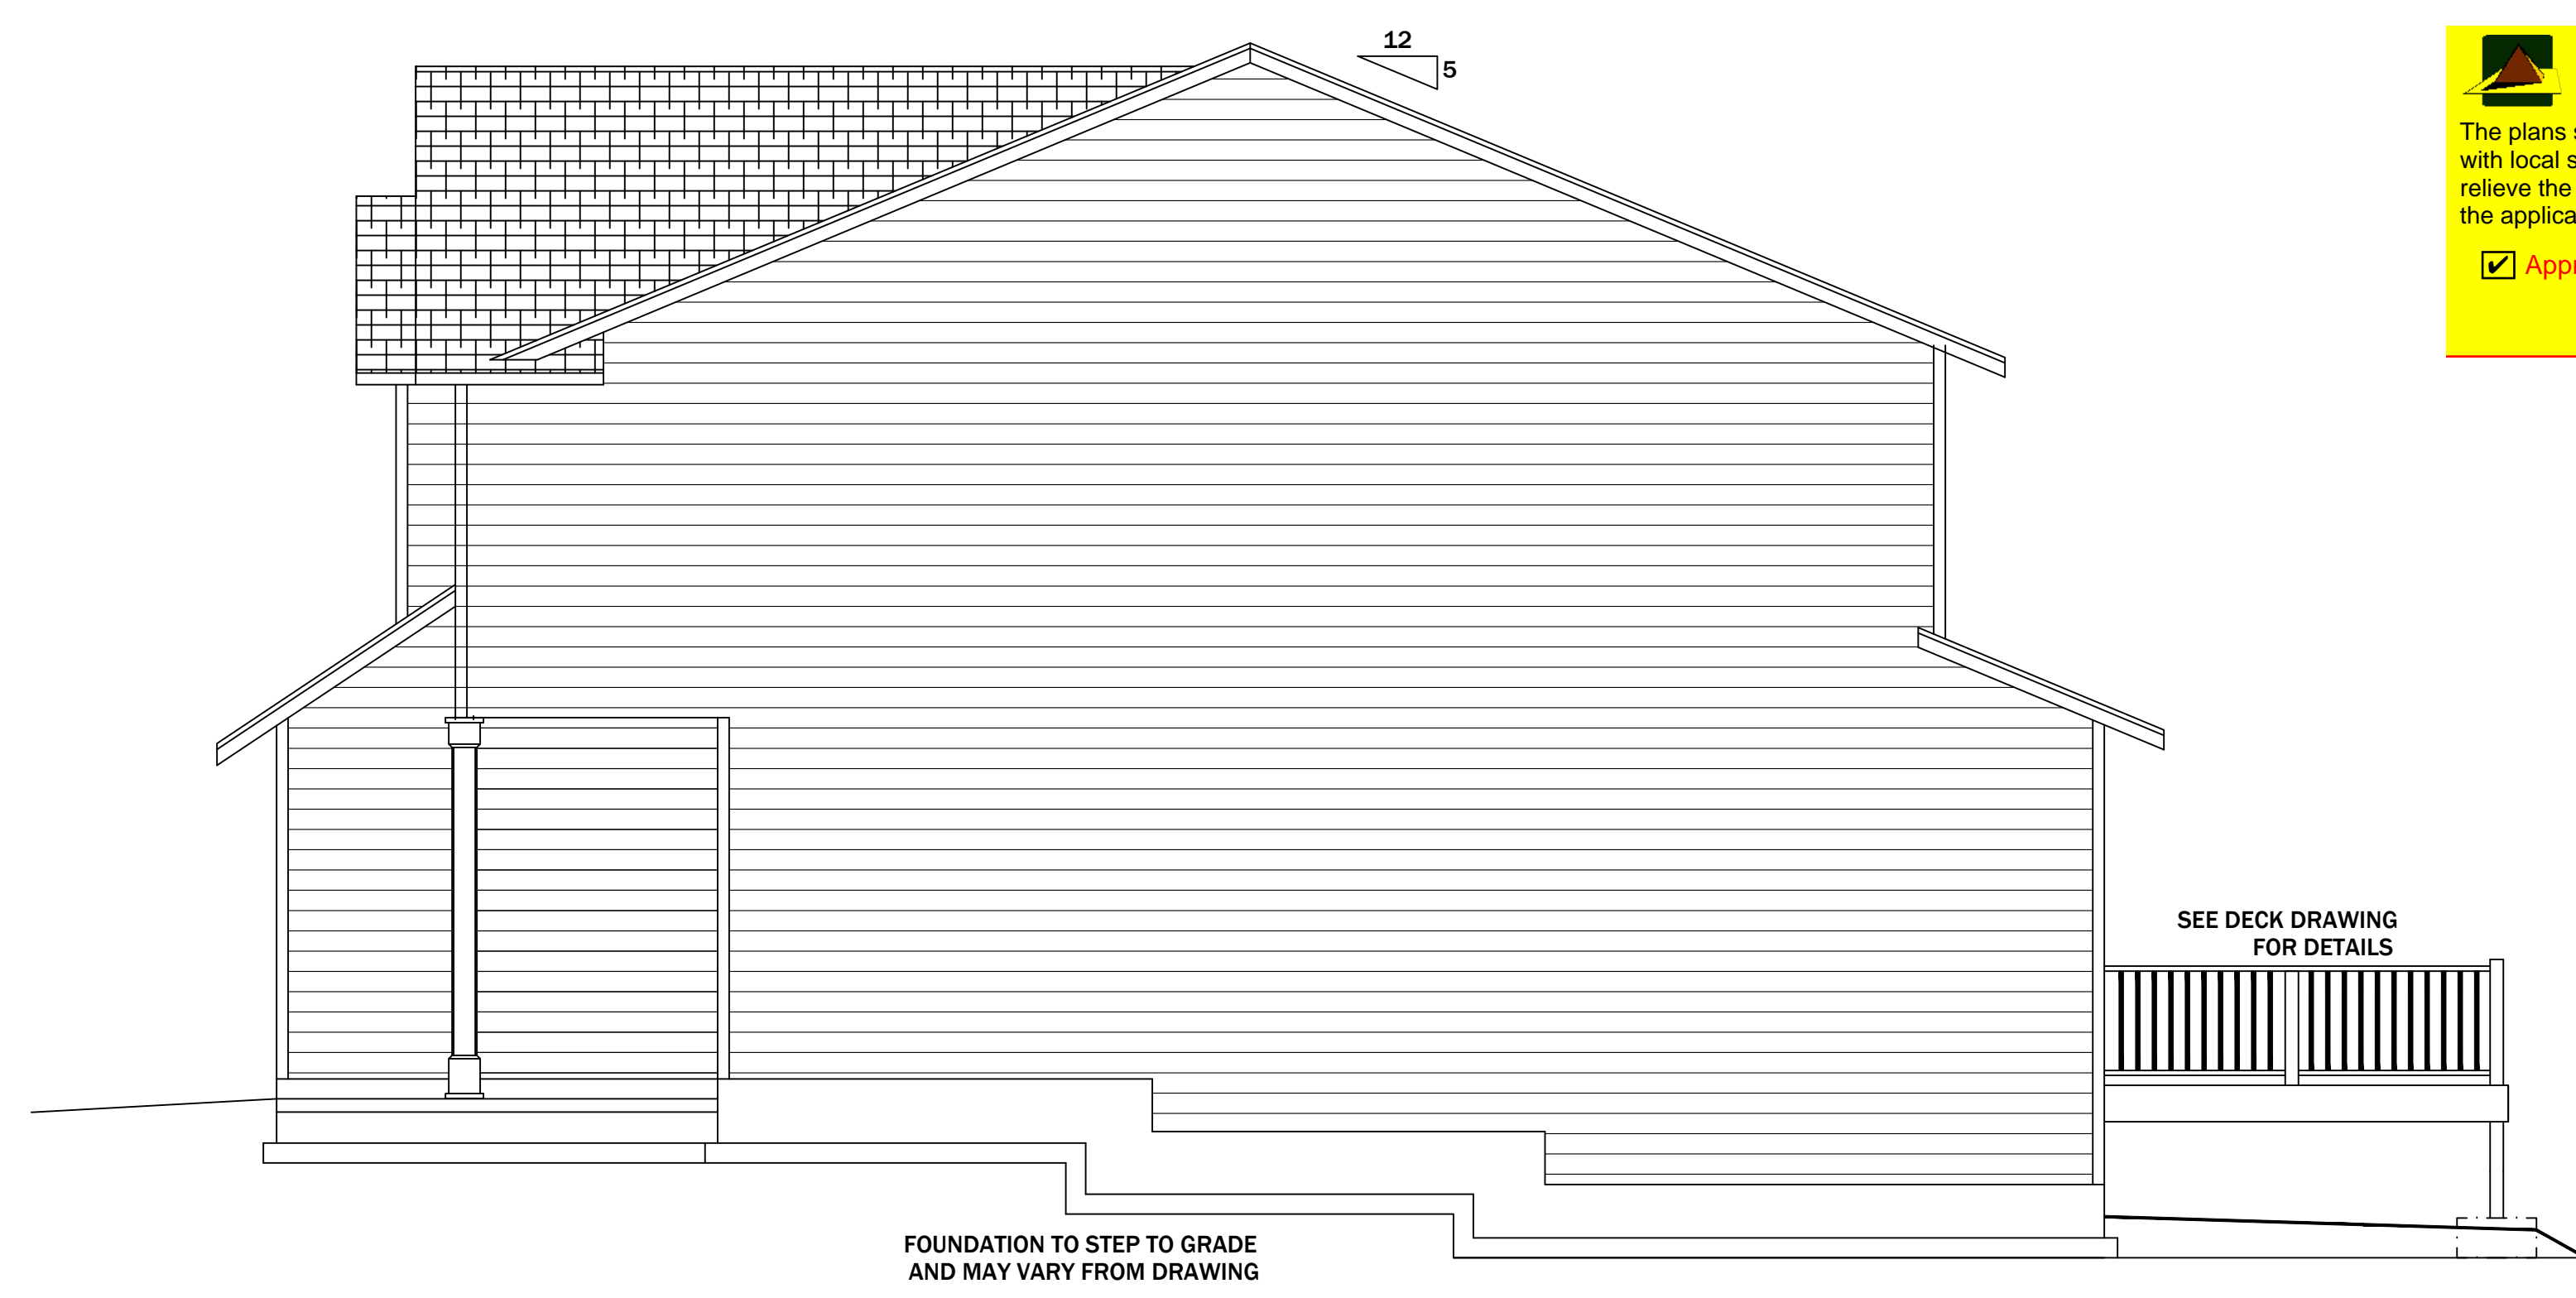
A1.1

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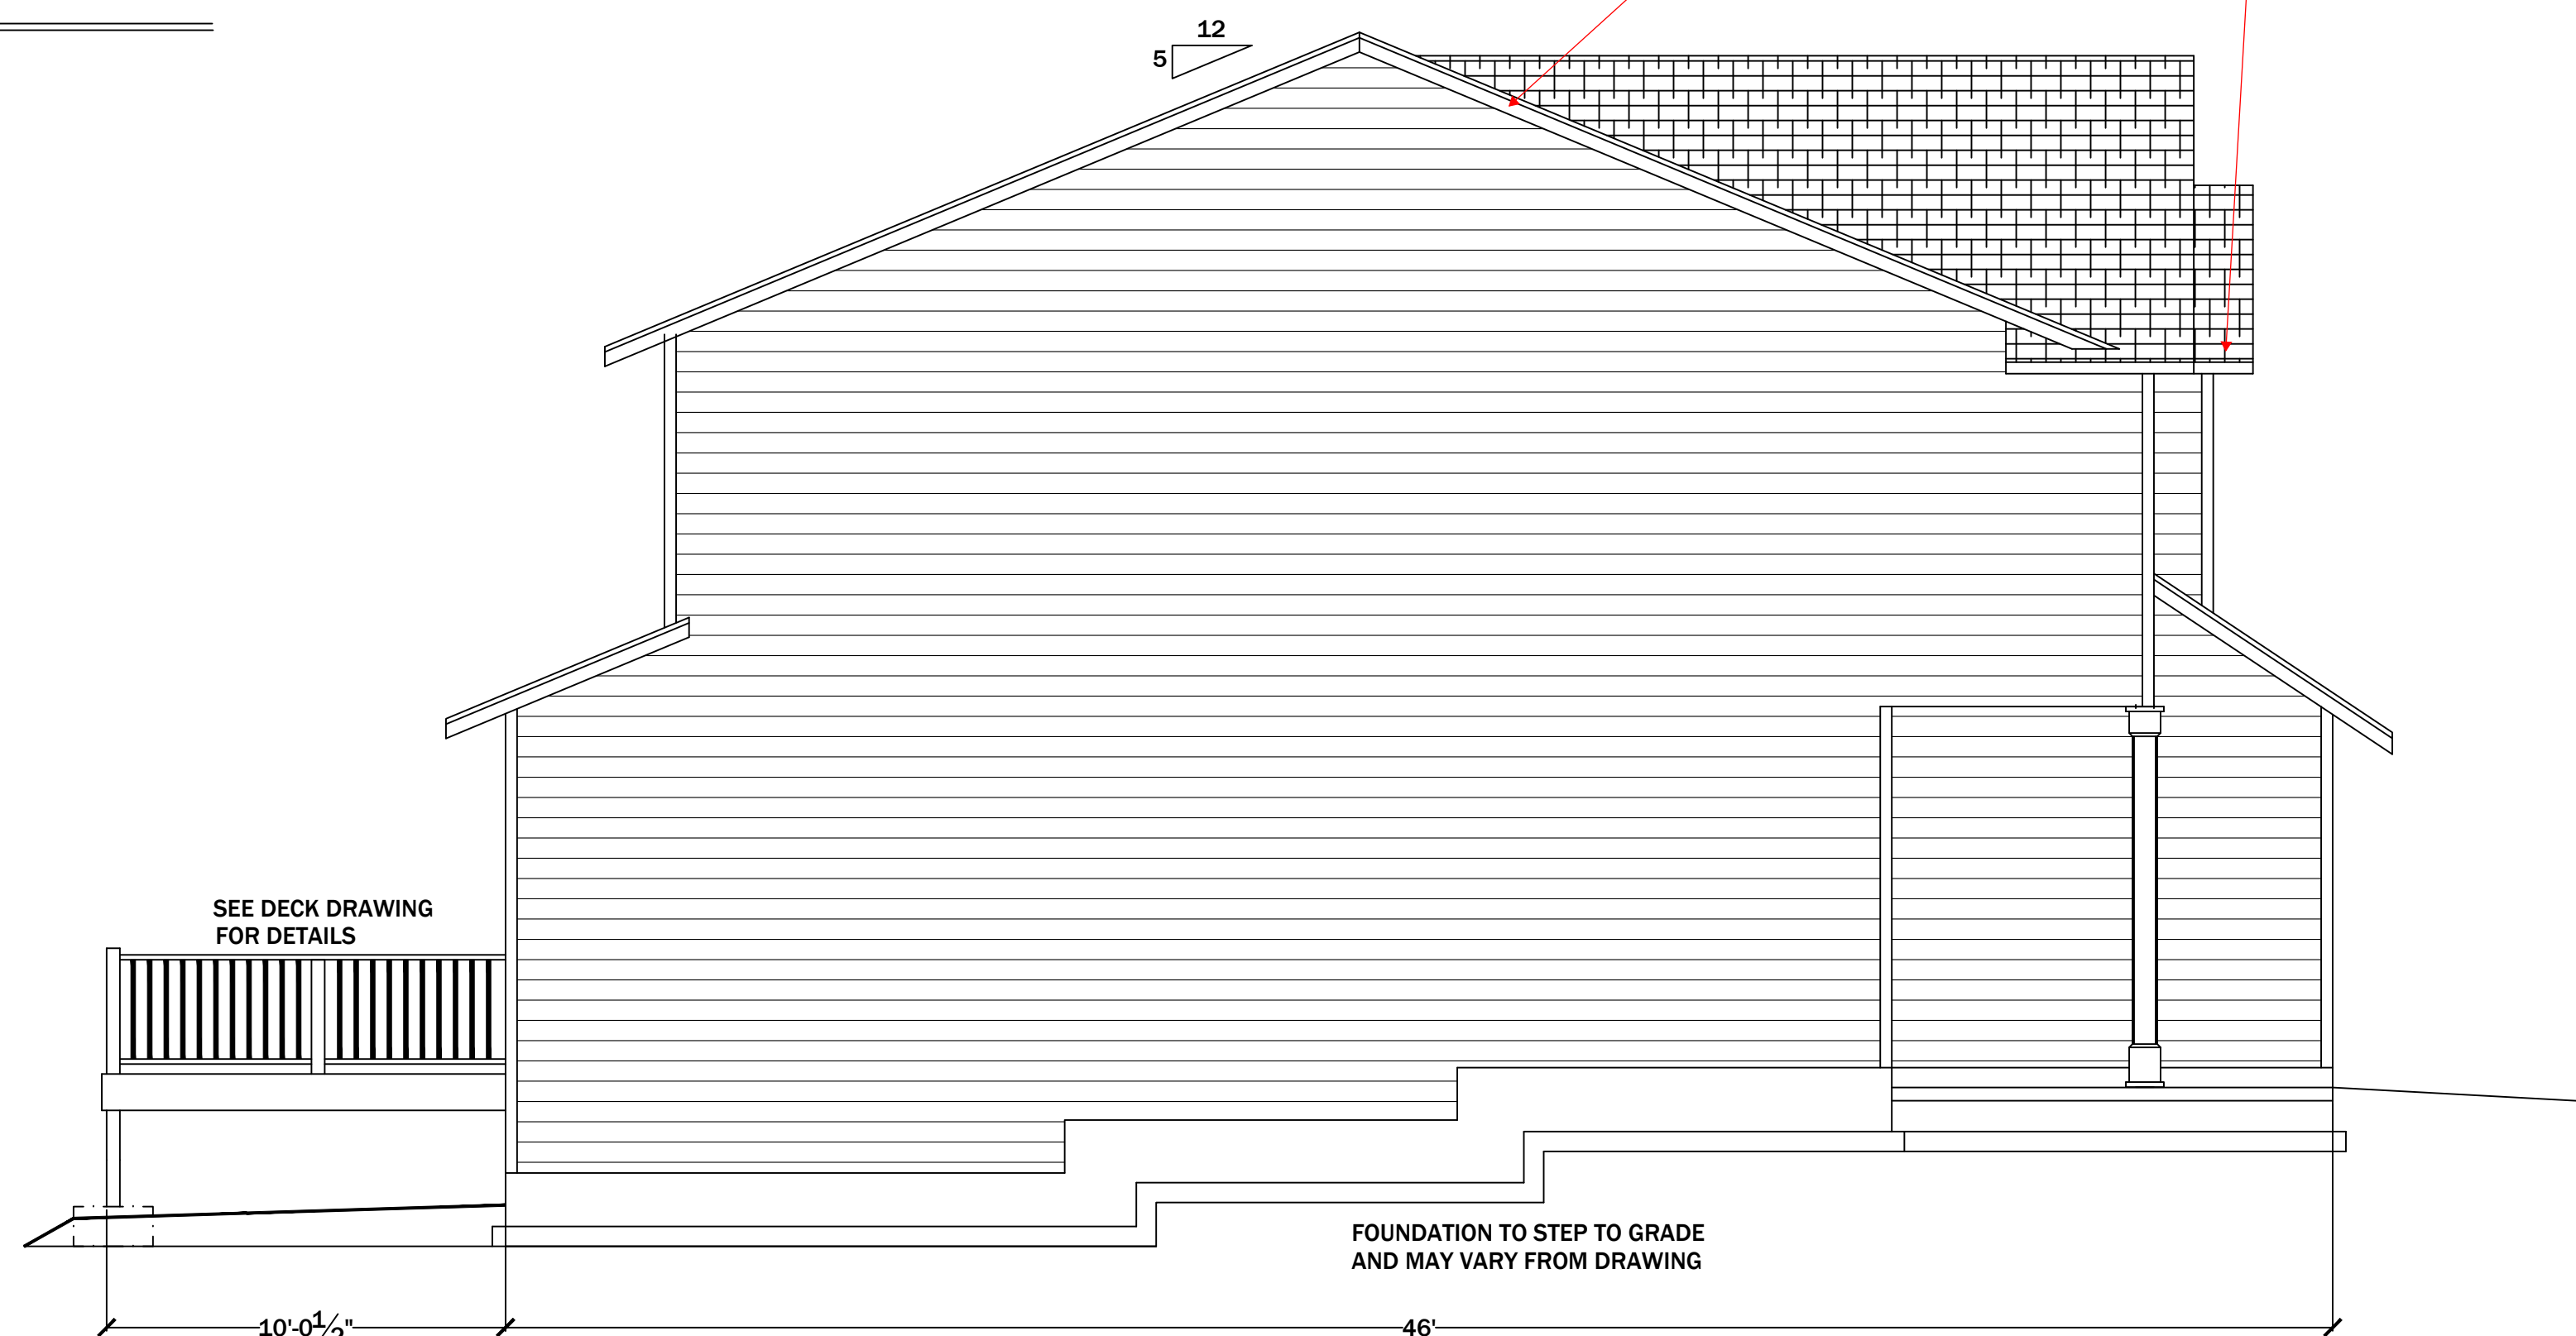
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Konrad Weber



RIGHT ELEVATION

1/4"=1'-0"



LEFT ELEVATION

1/4"=1'-0"

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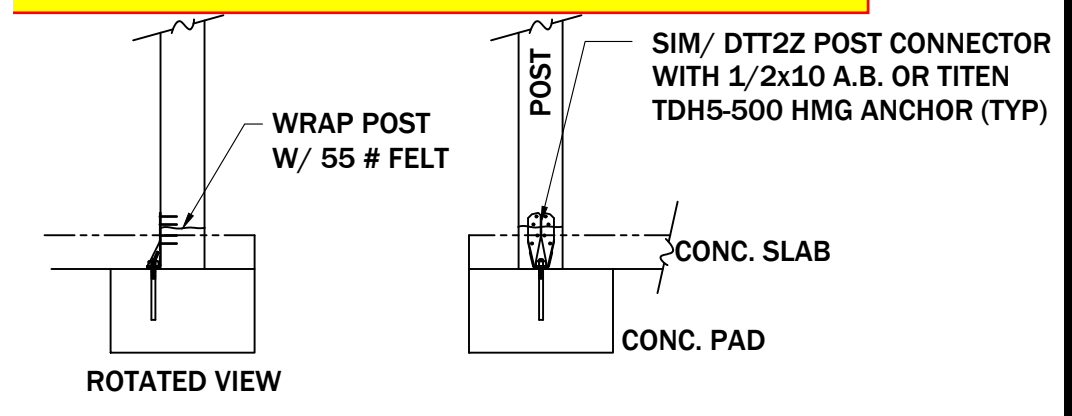
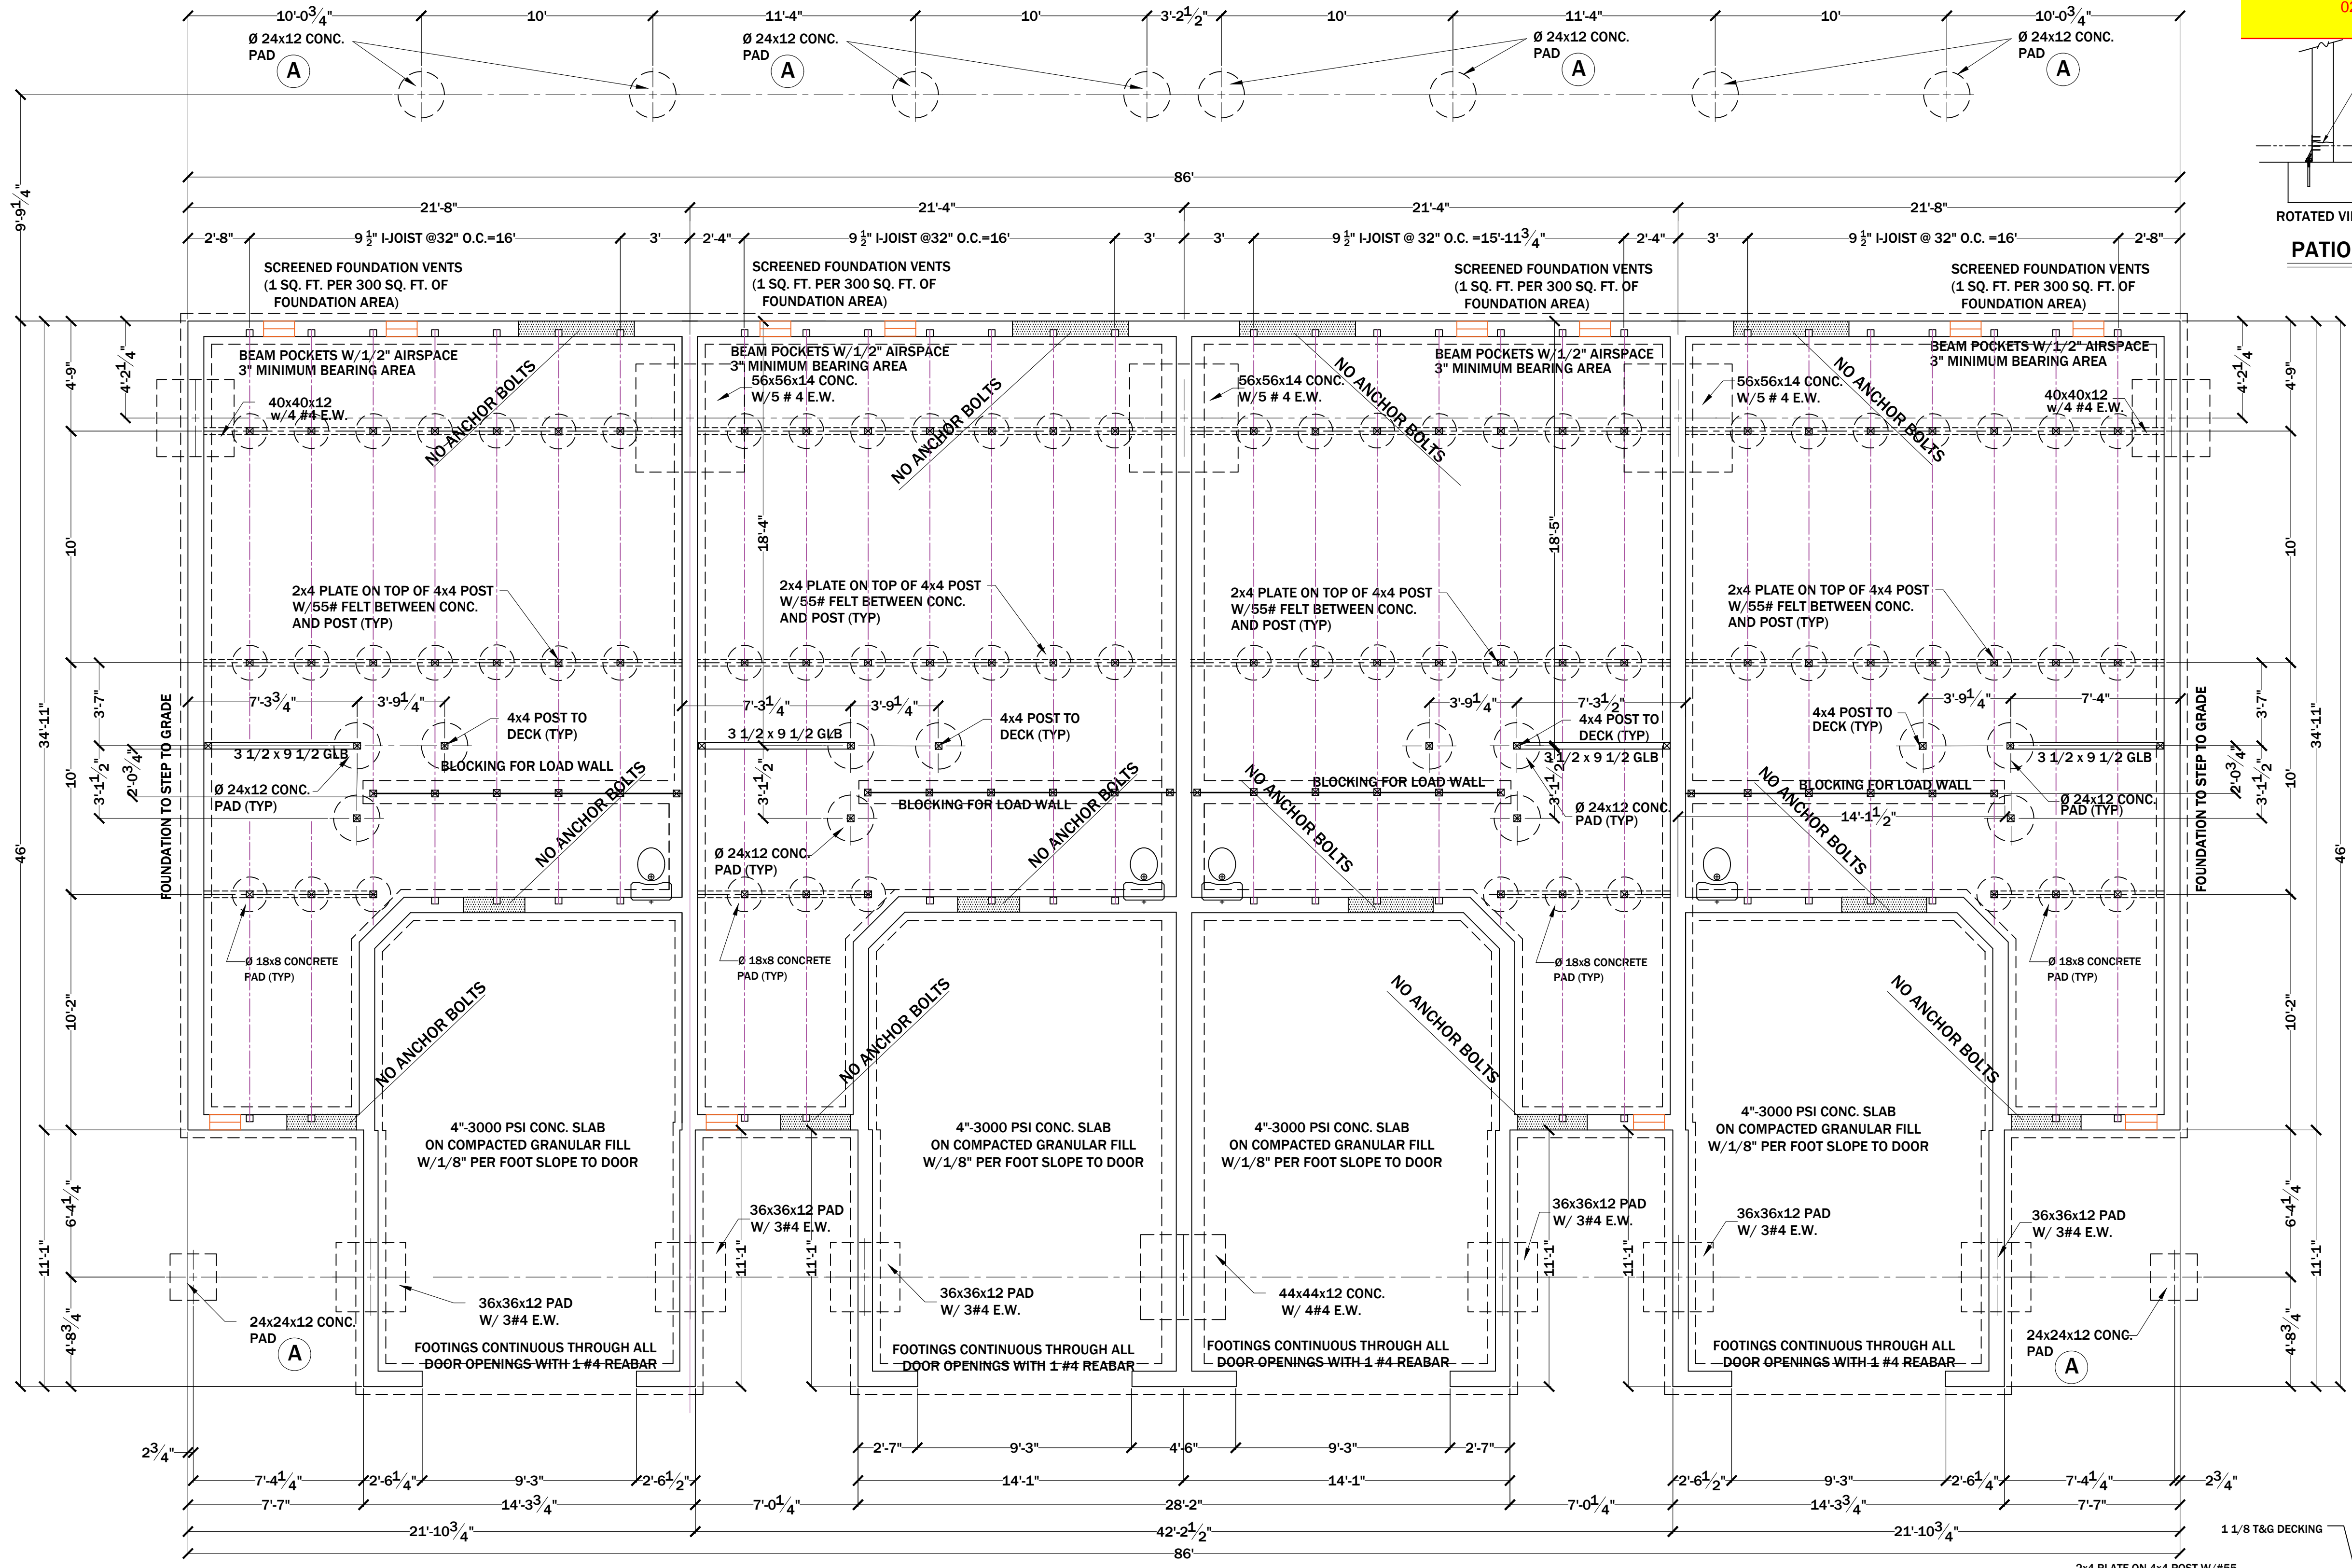
DWG BY: **N Sampson**

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A2.0




PATIO LOWER POST CONNECTION (A)

R403.1.6 Foundation Anchorage. All anchor bolts shall be located in the middle third of the width of the plate.

POINT LOAD PROVIDE CONTINUOUS FULL BEARING TO FOUNDATION

R502.7(2) Lateral restraint at supports in seismic D lateral restraint shall be provided at each intermediate support. Solid blocking 2" nominal full depth.

VENTILATION CALCULATIONS
481 SQ. FT. OF UNDER FLOOR AREA / 300 = 1.6 SQ. FT. OF VENTILATION REQUIRED (230 SQ. IN.)
FOUNDATION VENTS BASED ON 73 SQ. IN. OF VENTILATION.
APPROXIMATELY "3" FOUNDATION VENTS REQUIRED.

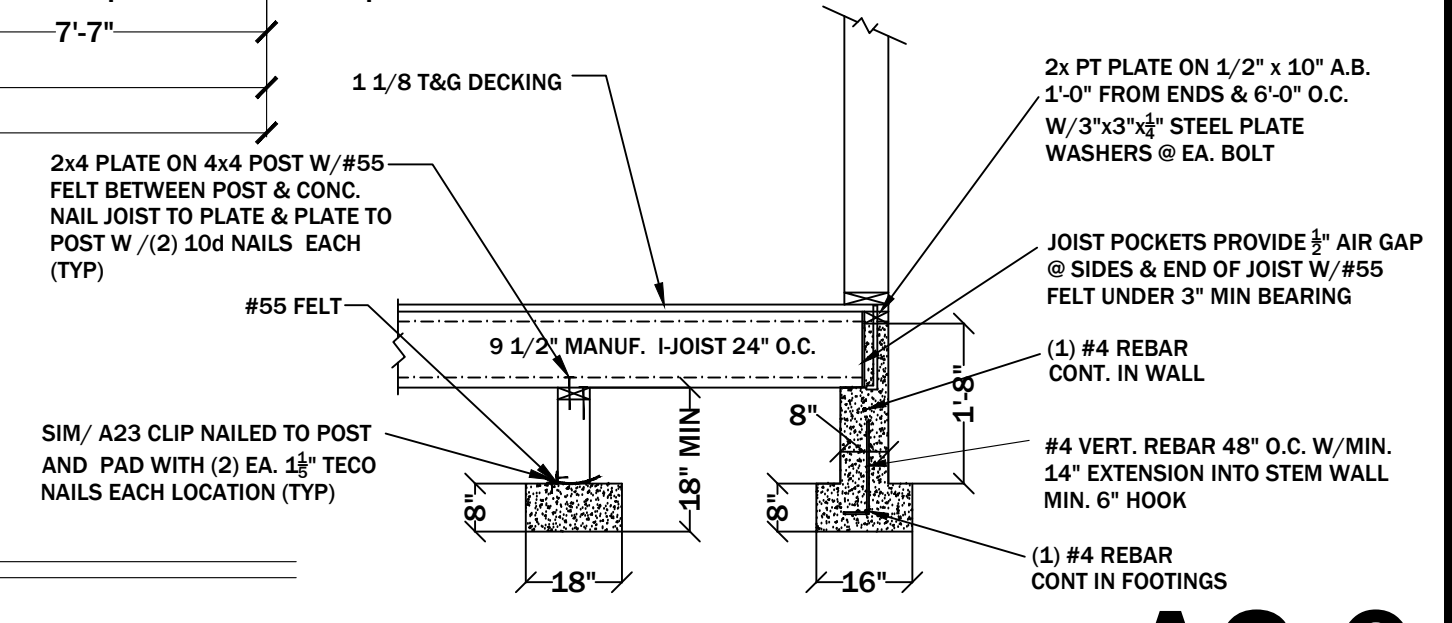

(TYP) FOUNDATION SECTION DETAIL (NTS)

FOUNDATION PLAN

SCALE: 1/4" = 1'-0"

SEE "S" PAGES (ENGINEERING SHEETS IN BACK OF DRAWING) FOR SHEAR WALL AND HOLD DOWN LOCATIONS. ALL LATERAL SPECIFICATIONS AND DETAILS WILL ALSO BE FOUND ON THESE PAGES.

A2.0

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NOTE:
EXT. HDRS. 4X10 #2 D.F. UP TO 6'-0" OPENING UNLESS NOTED ON PLAN OR ENGINEERING.

ALL EXTERIOR AND 75% OF THE INTERIOR LIGHTING TO BE HIGH LUMINAR FIXTURES

U-VALUE FOR ALL GLAZING TO BE .28 OR LESS

SEE ENGINEERING "S" PAGES FOR HOLD DOWNS, BEAM SIZES, WALL AND ROOF NAILING SCHEDULES

KITCHEN SINK & SHOWERS 1.75 GPM
ALL OTHERS 1.0 GPM

FALL PROTECTION REQUIRED IF WINDOW SILL IS 24" ABOVE FINISHED FLOOR & 72" ABOVE FINISH GRADE SEE (IRC R312.2.1)

EXTERIOR WALL STUDS 16" O.C.



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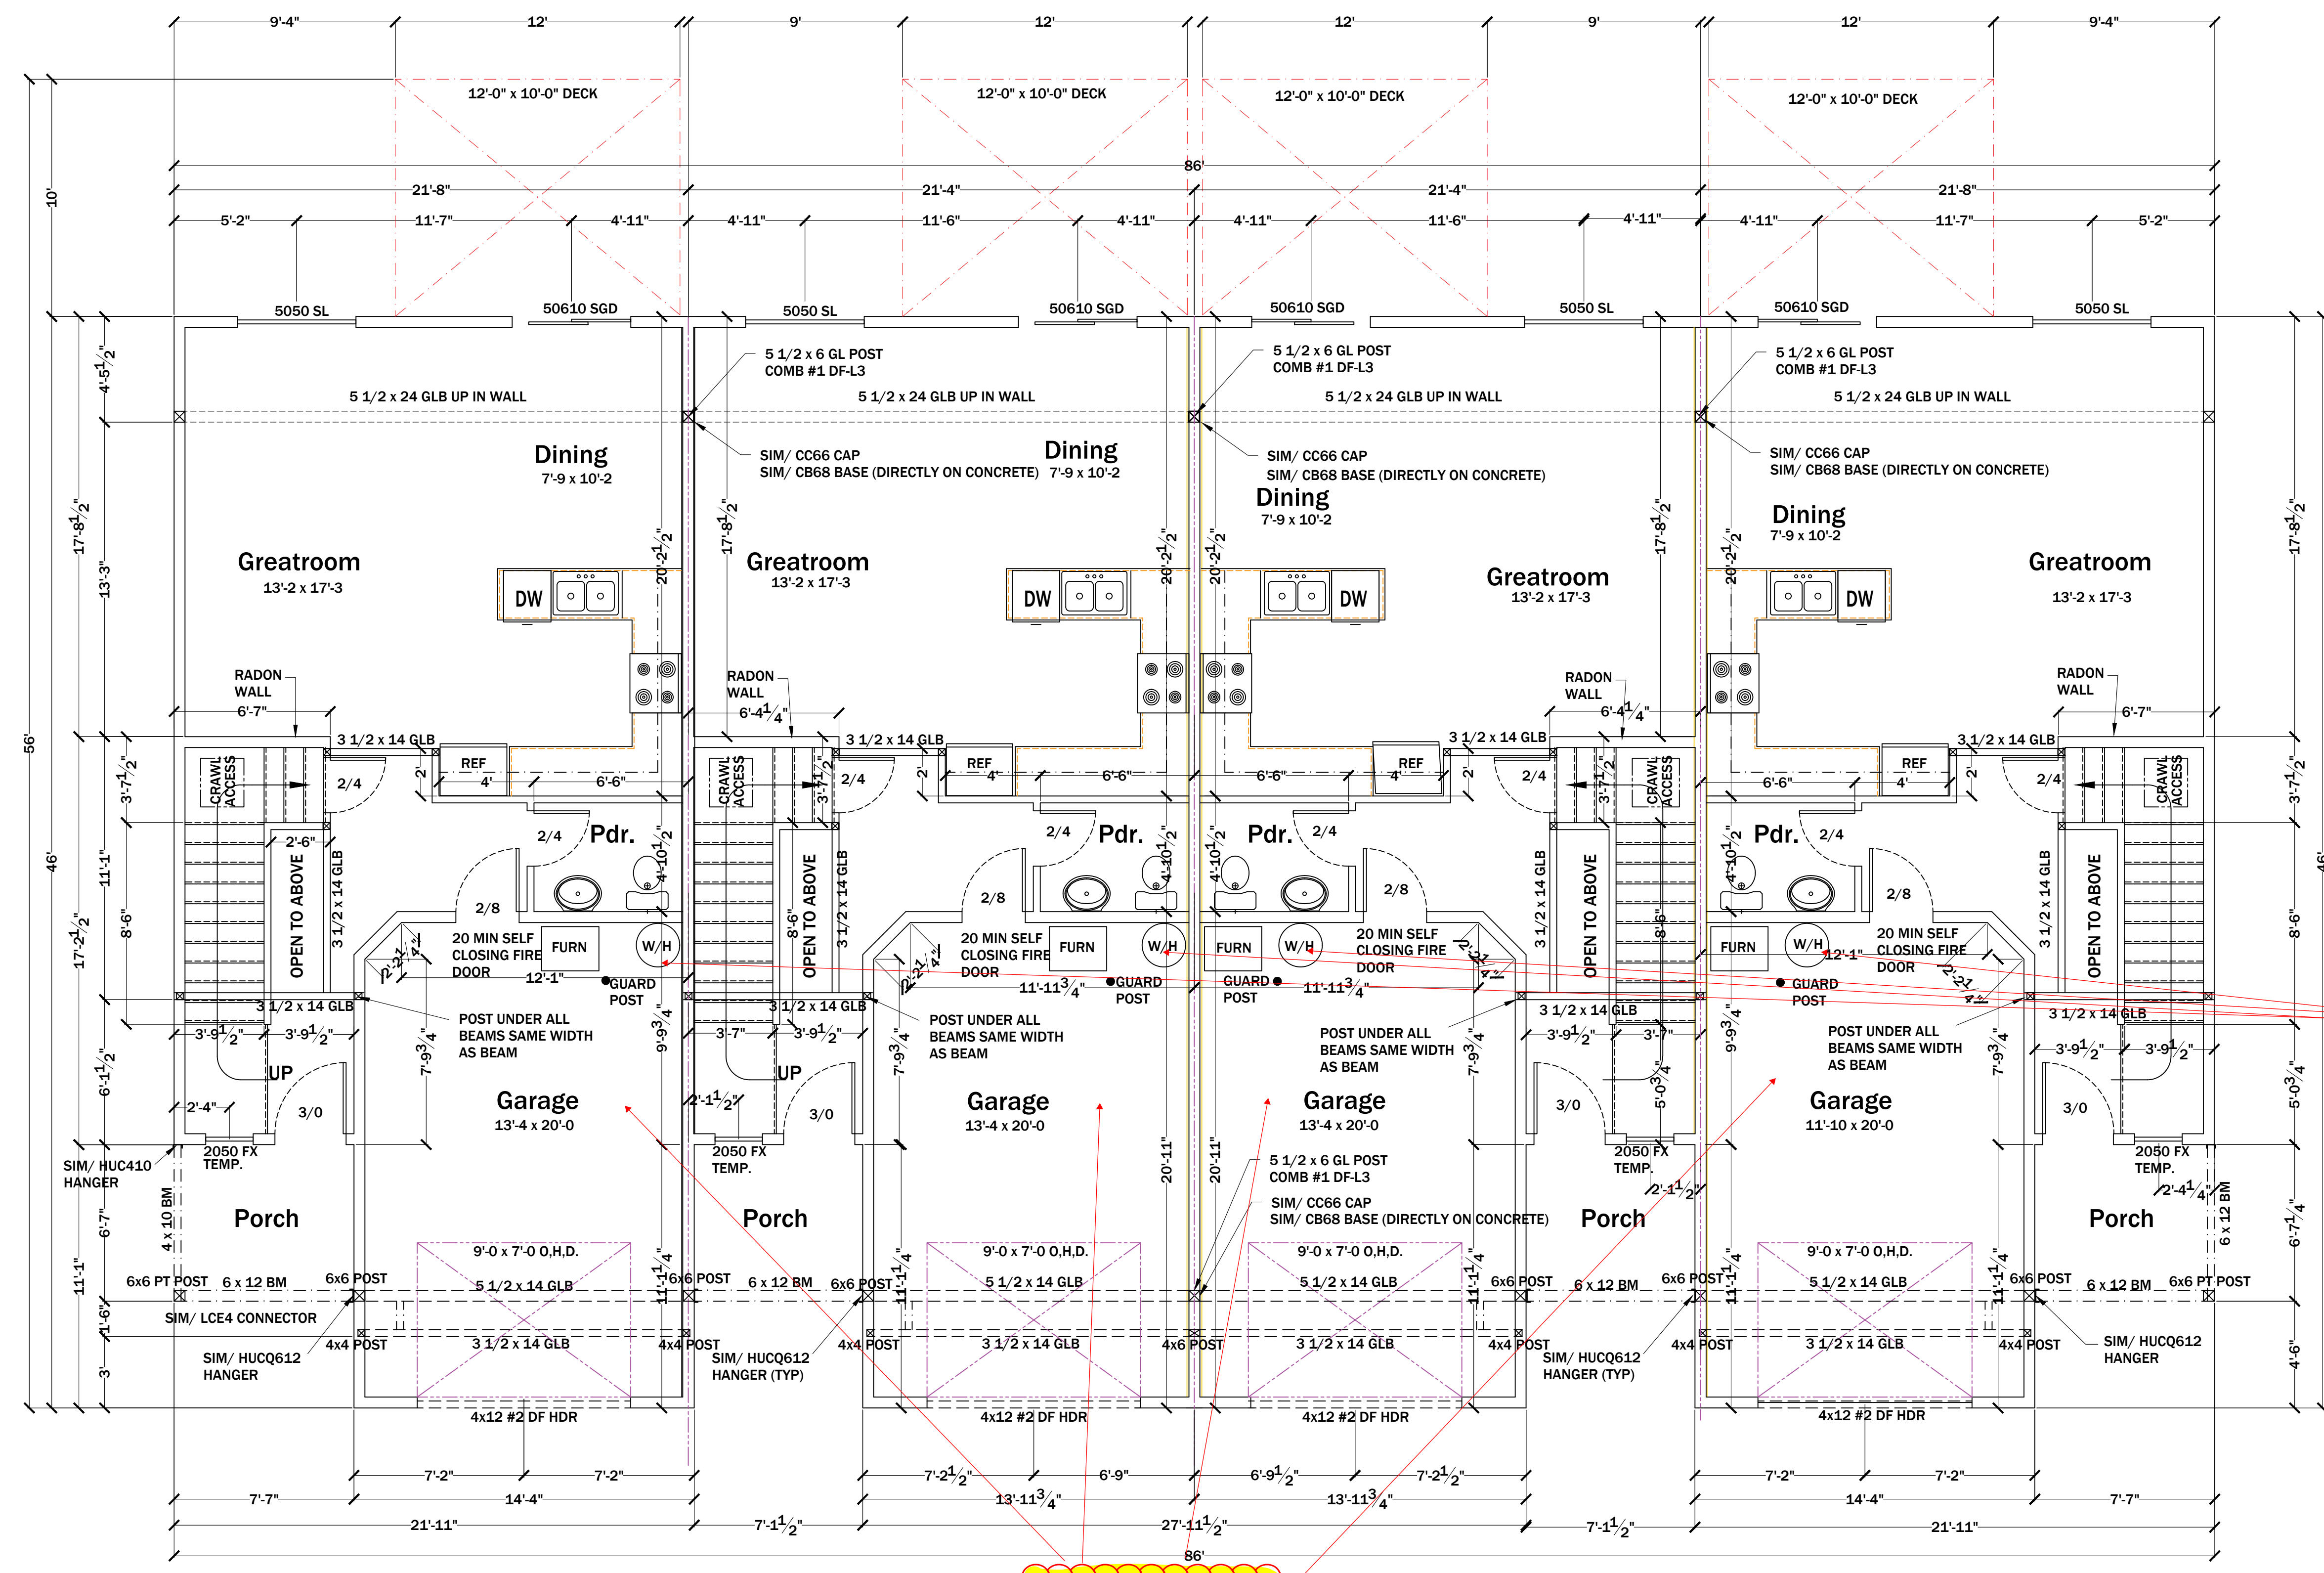
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190820

DRAWN FOR:

UPCS07.2 In seismic design categories water heaters shall be anchored or strapped to resist horizontal displacement due to earthquake motion.
Relief valves shall comply with UPC Section 608.3 with a drain pipe per UPC Section 608.5

R302.2 Townhouses
Common walls separating townhouses shall be designed as fire-resistance rating in accordance with R302.2. The common wall shared by two townhouses shall be constructed without plumbing or mechanical equipment, ducts or vents in the cavity of the common wall. The wall shall be sealed for the exposure from both sides and shall extend to and be tight against exterior walls and the underside of roof sheathing. Electrical shall be in accordance with Chapter 34-43

[Per Table R702.3.5] 1 7/8" nails or equivalent screws 6" O.C. fastening for 5/8" gypsum wall board on garage ceiling beneath habitable space.



MAIN FLOOR
SCALE: 1/4" = 1'-0"

REVISION	DATE

DWG BY: **N Sampson**
CHK BY:
DATE: **08/20/2019**
FILE NAME: **Lawffer**

SHEET NUMBER

A3.0

R302.2 Townhouses
 Common walls separating townhouses shall be assigned a fire-resistance rating in accordance with R302.2. The common wall shared by two townhouses shall be constructed without plumbing or mechanical equipment, ducts or vents in the cavity of the common wall. This wall shall be rated for fire exposure from both sides and shall extend to and be tight against exterior walls and the underside of roof sheathing. Electrical shall be in accordance with Chapter 34-43

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NOTE:
 EXT. HDRS. 4X10 #2 D.F. UP TO 6'-0" OPENING UNLESS NOTED ON PLAN OR ENGINEERING.
 ALL EXTERIOR AND 75% OF THE INTERIOR LIGHTING TO BE HIGH LUMINAR FIXTURES
 U-VALUE FOR ALL GLAZING TO BE .28 OR LESS
 SEE ENGINEERING "S" PAGES FOR HOLD DOWNS, BEAM SIZES, WALL AND ROOF NAILING SCHEDULES
 KITCHEN SINK & SHOWERS 1.75 GPM ALL OTHERS 1.0 GPM
 FALL PROTECTION REQUIRED IF WINDOW SILL IS 24" ABOVE FINISHED FLOOR & 72" ABOVE FINISH GRADE SEE (IRC R312.2.1)
 EXTERIOR WALL STUDS 16" O.C.



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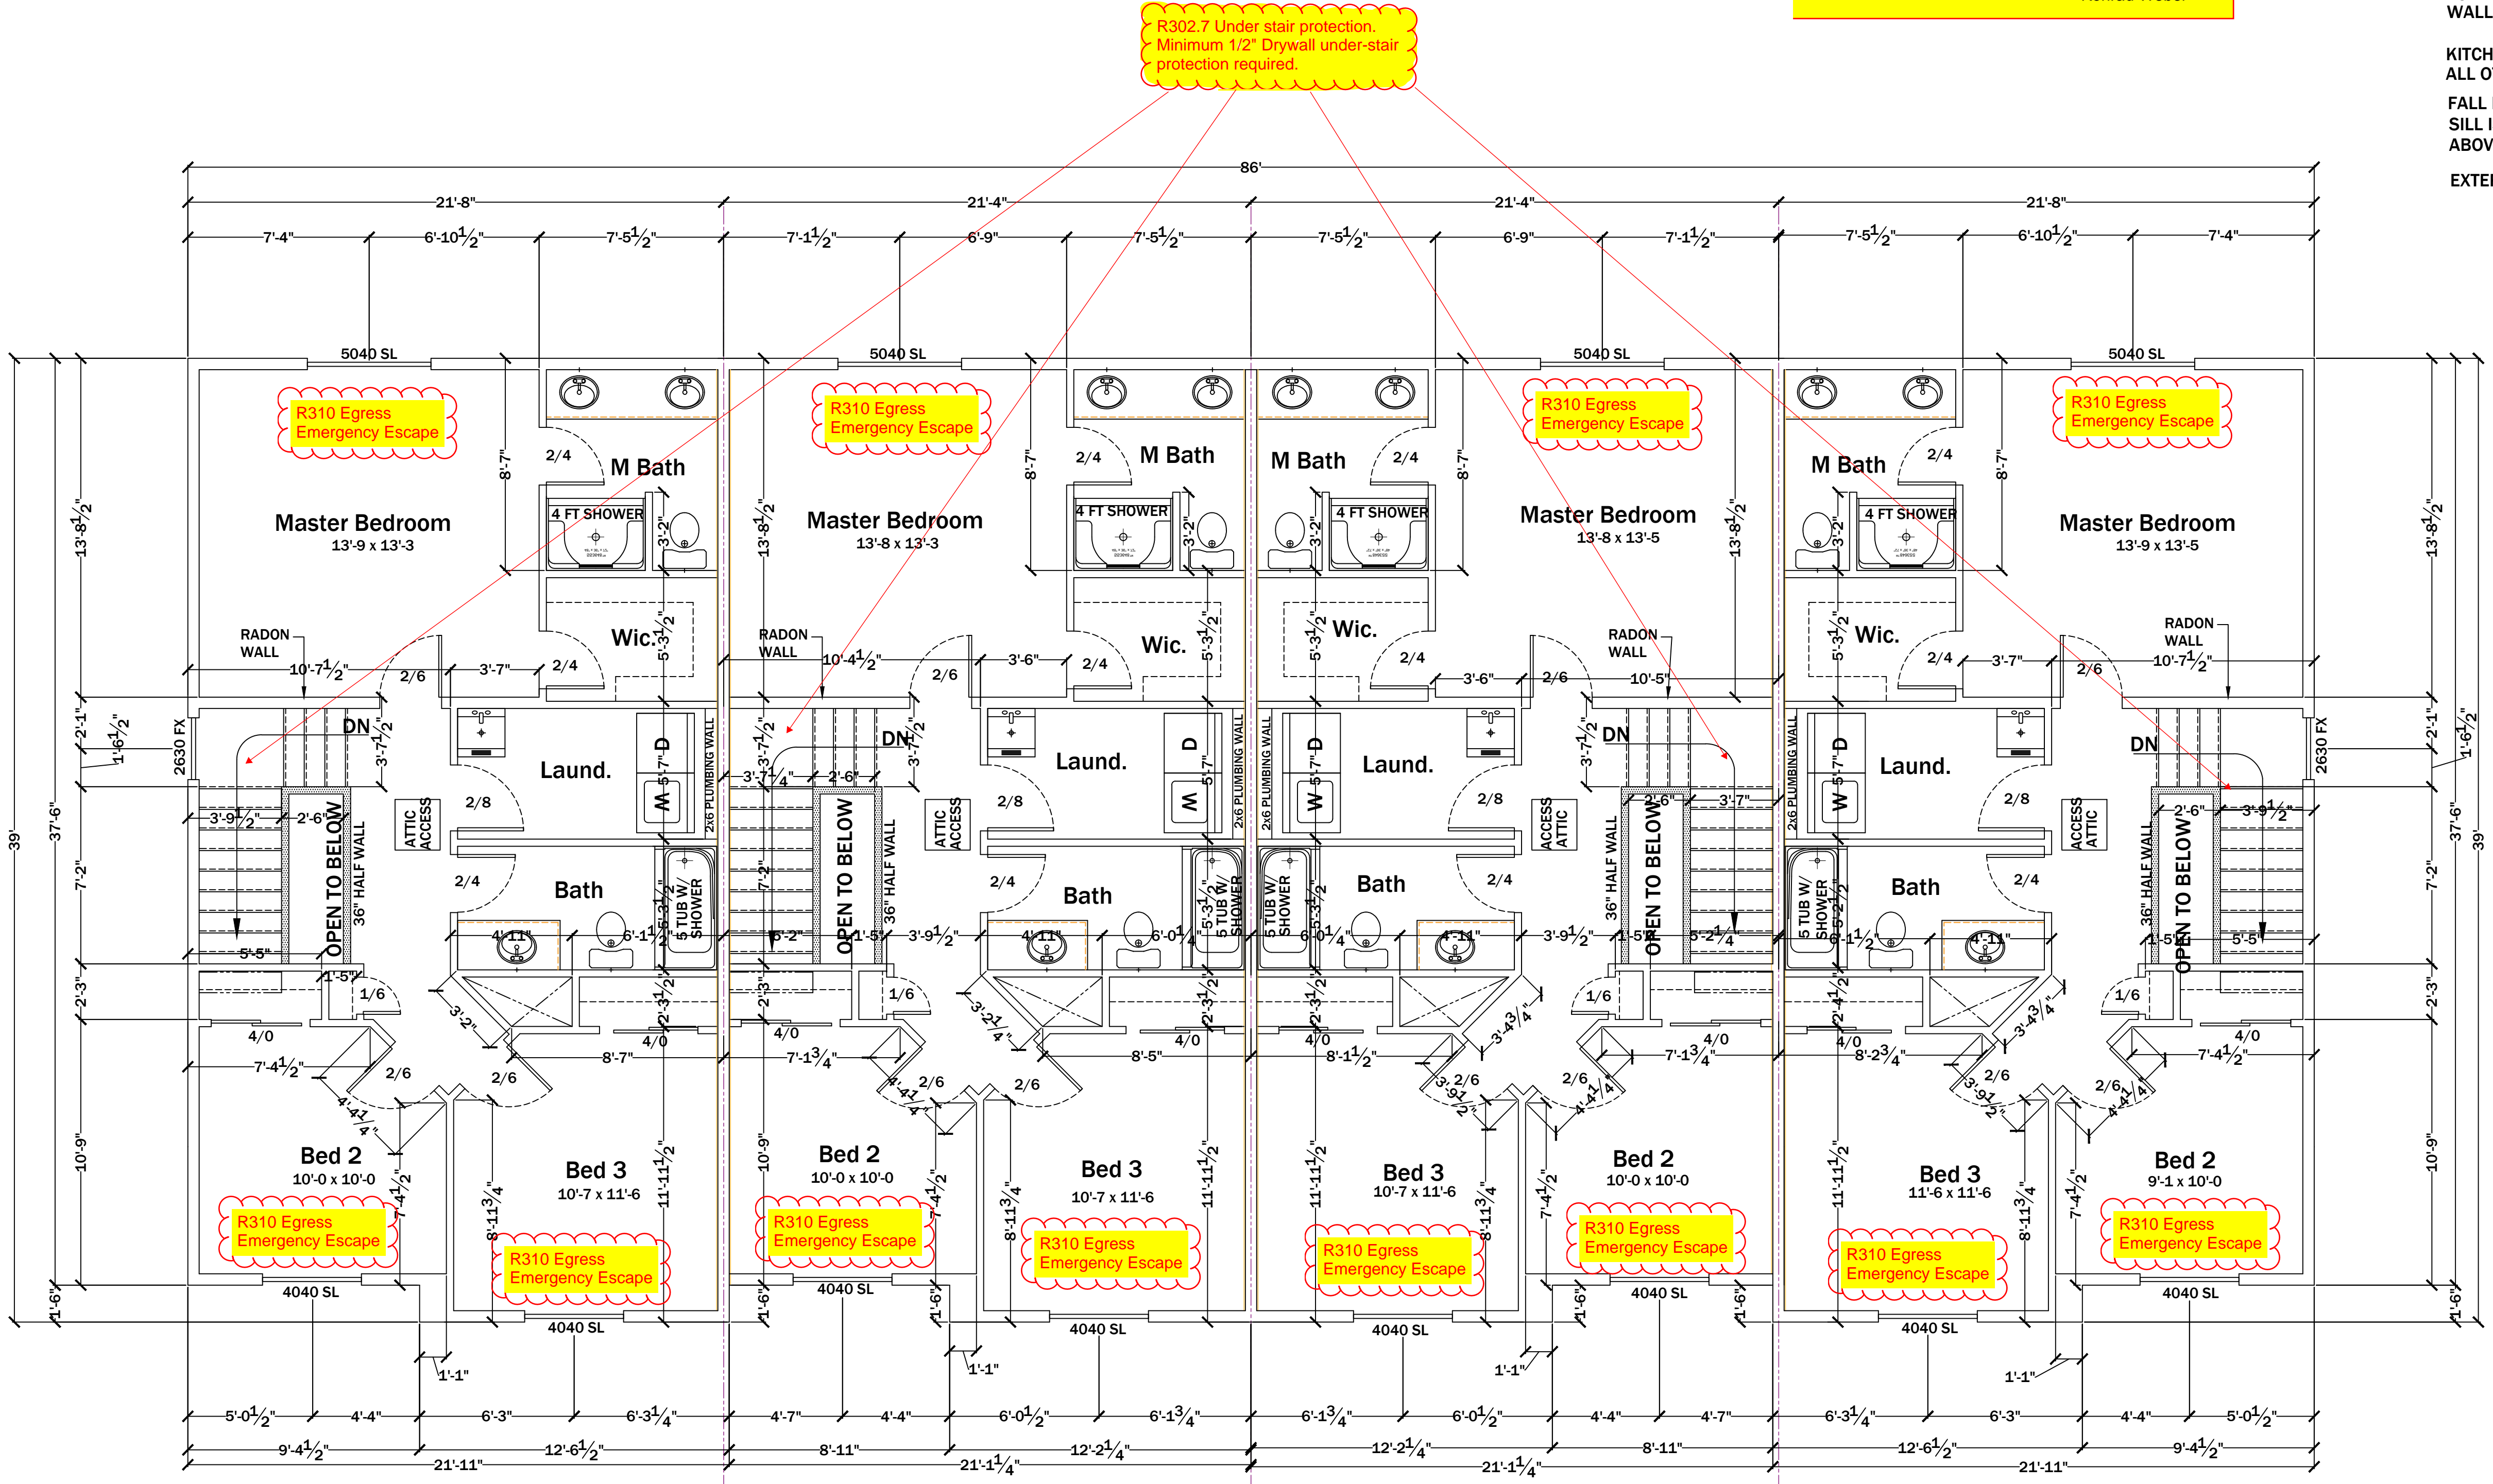
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SHEET NUMBER

A4.0



UPPER FLOOR
 SCALE: 1/4" = 1'-0"

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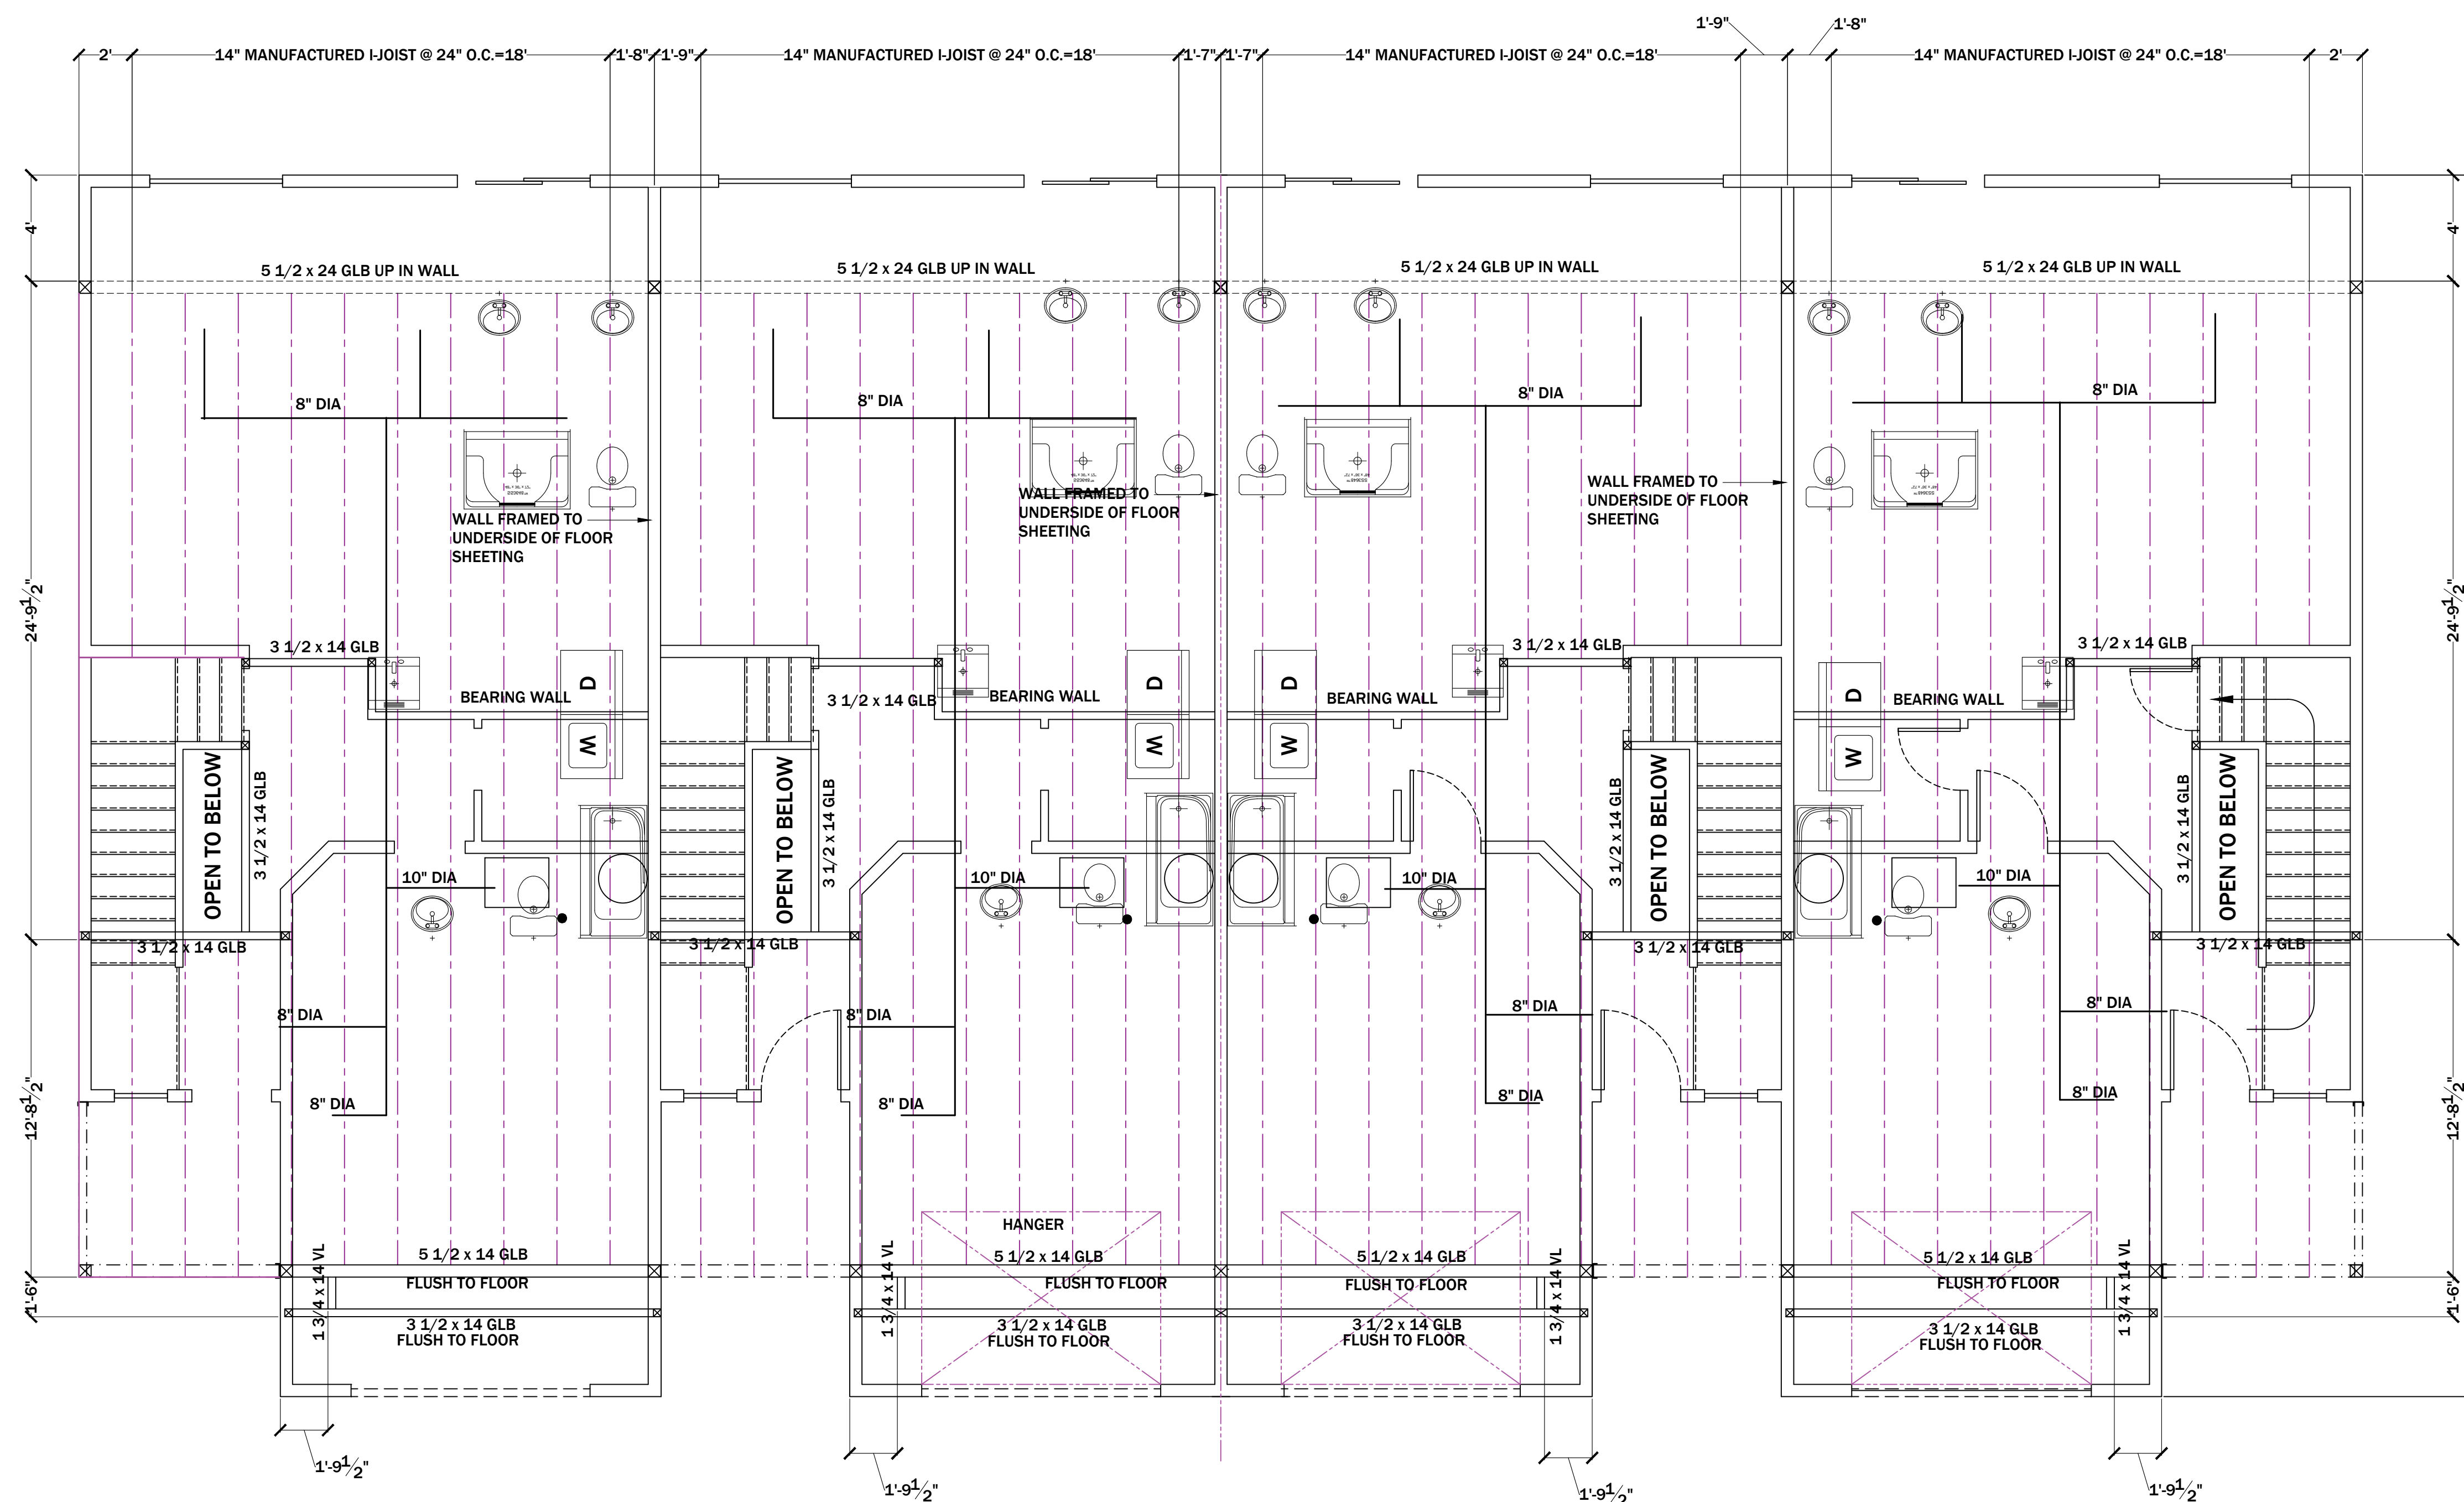
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DATE: **08/20/2019**

FILE NAME: **Lawffer**

SHEET NUMBER

A4.1



UPPER FLOOR JOIST

SCALE: 1/4" = 1'-0"


REFER TO MANUFACTURES LAYOUT FOR EXACT SPECS
THIS IS TO BE USED AS A GUIDE ONLY

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ROOF PLAN

SCALE: 1/8" = 1'-0"

REFER TO MANUFACTURES LAYOUT FOR EXACT SPECS
 THIS IS TO BE USED AS A GUIDE ONLY

ATTIC VENTILATION

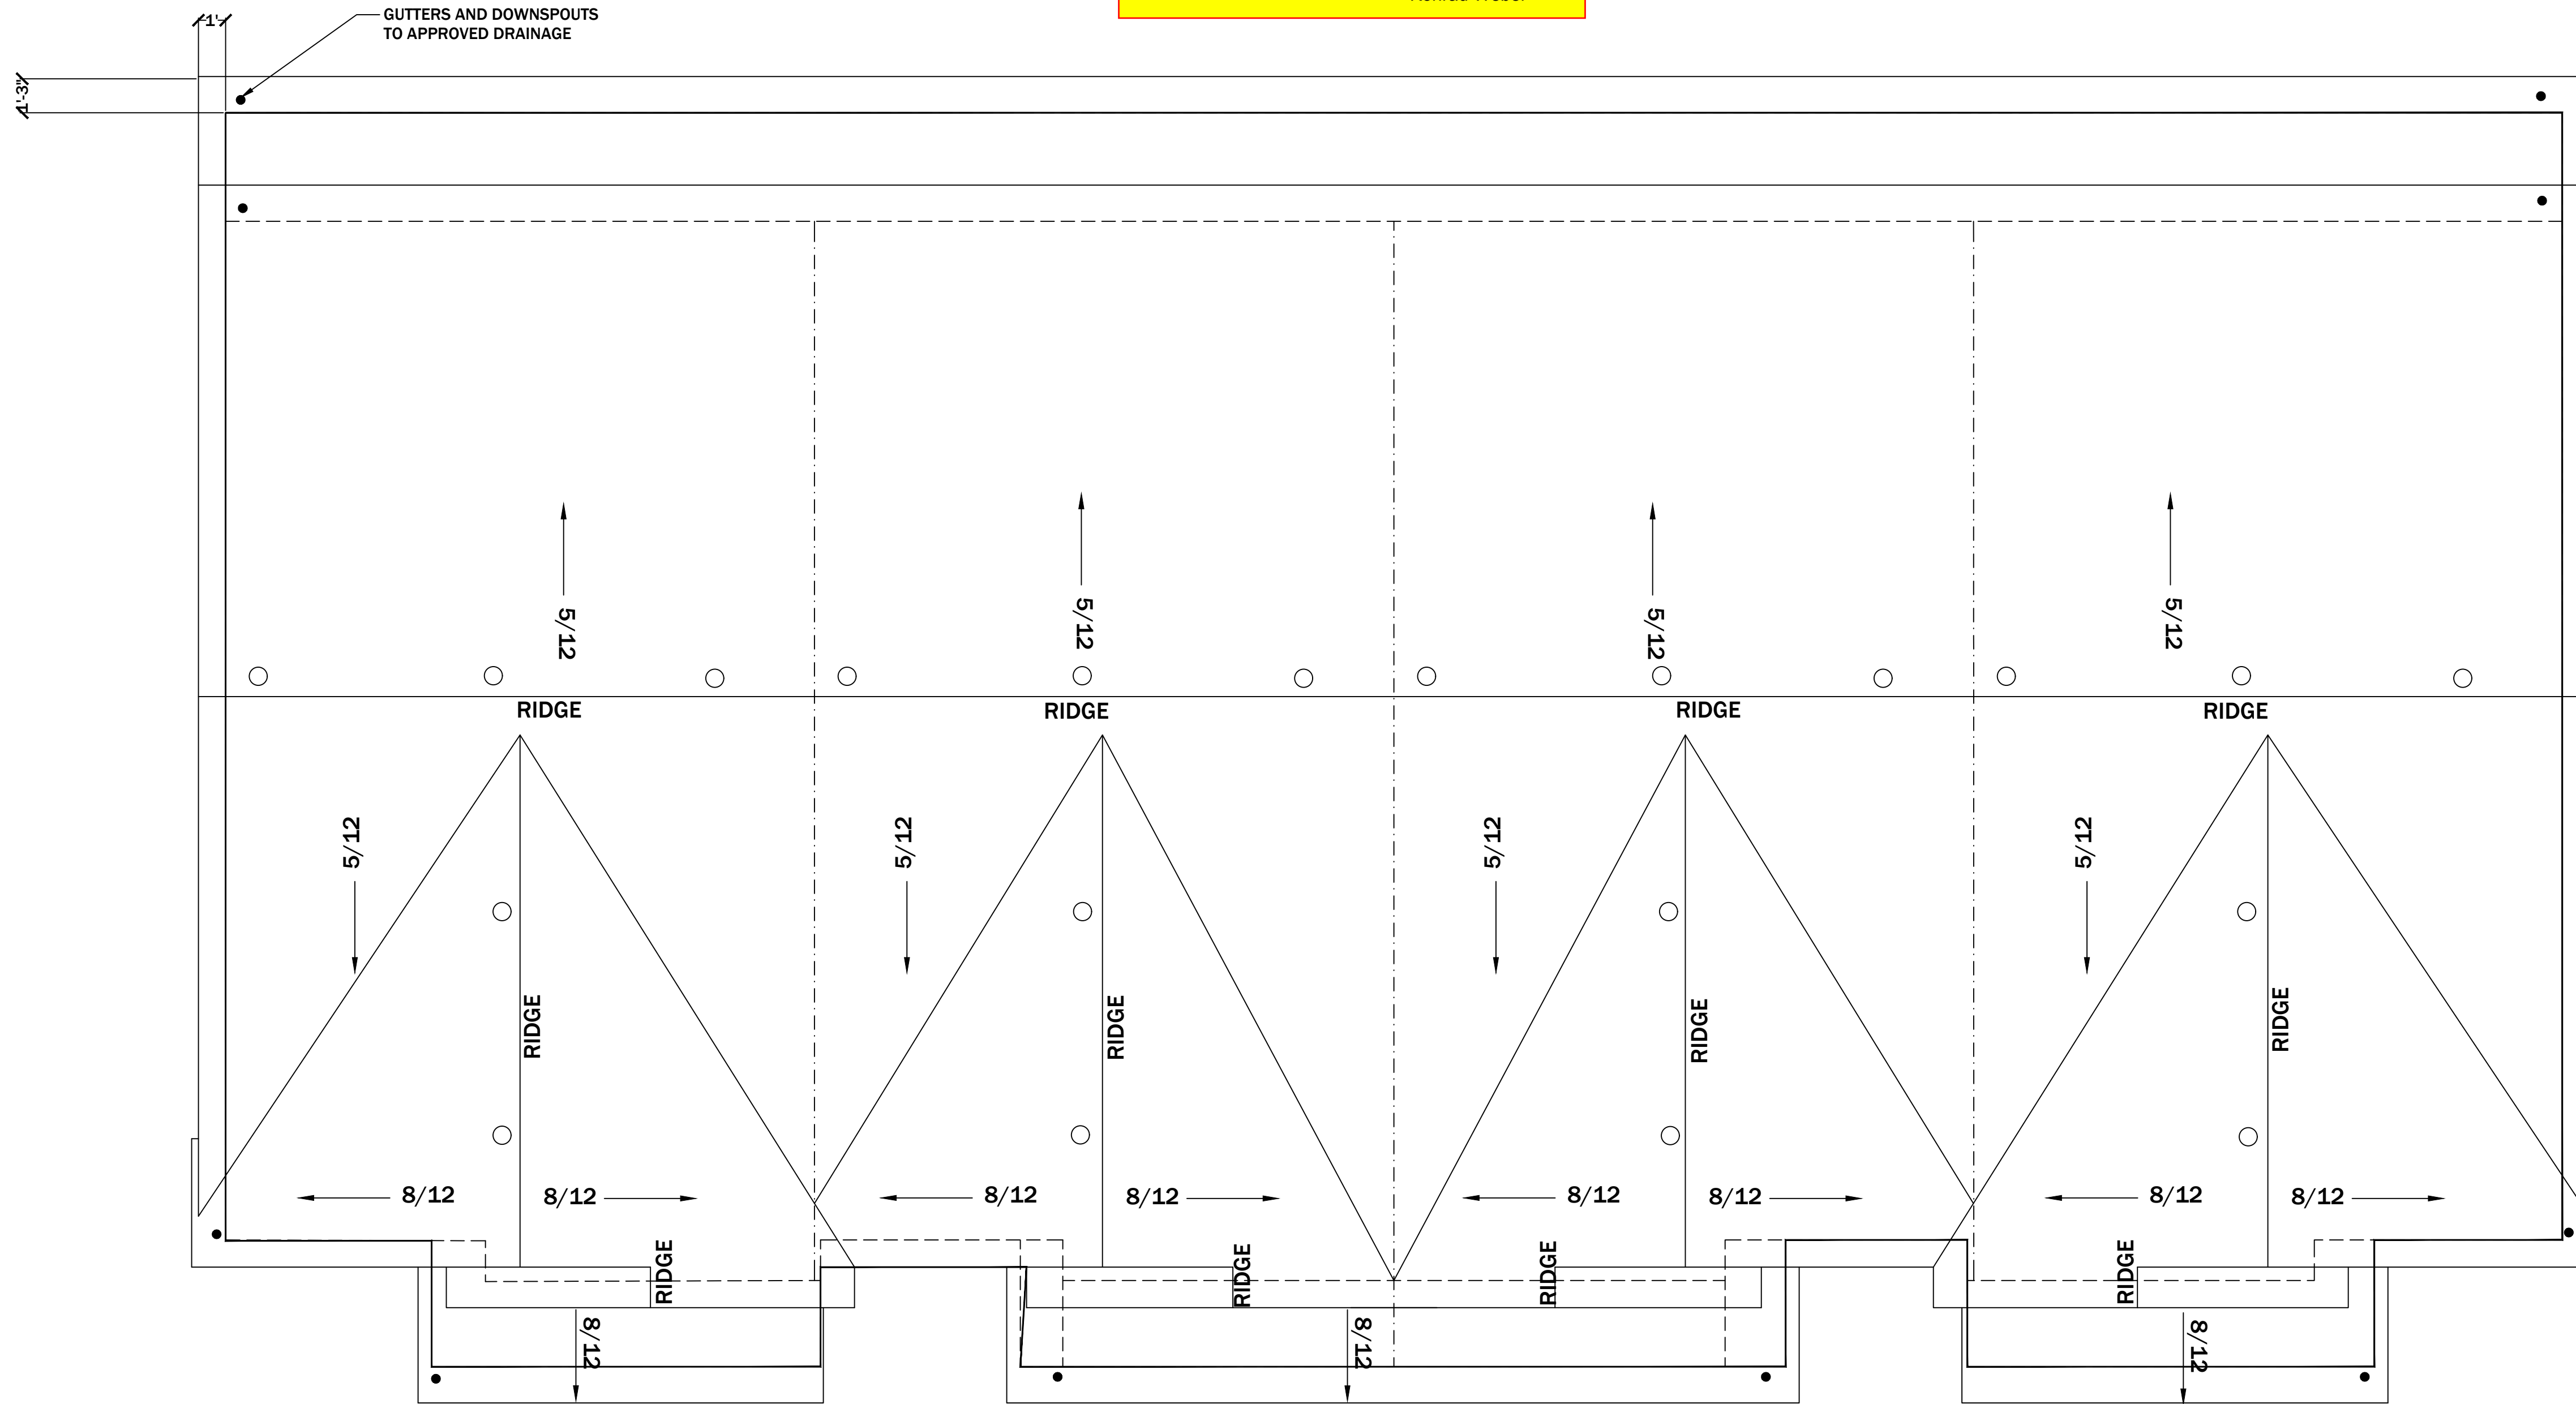THE NET FREE VENTILATING AREA SHALL NOT BE LESS THAN 1/150 OF THE AREA OF SPACE TO BE VENTILATED, THE AREA MAY BE 1/300 PROVIDING AT LEAST 50% OF THE REQUIRED VENTILATING AREA IS LOCATED IN THE UPPER PORTION OF THE SPACE TO BE VENTILATED, AND LOCATED AT LEAST 3 FEET ABOVE THE EAVE VENTS, WITH THE BALANCE OF THE VENTILATION PROVIDED BY THE EAVE VENTS.
 THE OPENING AREAS SHALL BE COVERED WITH CORROSION RESISTANT METAL MESH WITH A OPENING SIZE 1/4 INCH IN DIMENSION.

VENTILATION CALCULATIONS AREA

3844 SQ. FT. EACH OF ATTIC AREA/300= 12,81 SF OF VENTILATION REQUIRED (1845 SQ. IN.)
 HIGH ROOF VENTS = 922 SQ. IN.
 LOW ROOF VENTS = 922 SQ. IN.
 ROOF VENTS BASED ON 50 SQ. IN. OF VENTILATION.
 APPROXIMATELY "18" ROOF VENTS REQUIRED.
 EAVE VENTS PROVIDED BY (2x12 SCREENED VENT BLOCKS)



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A5.0

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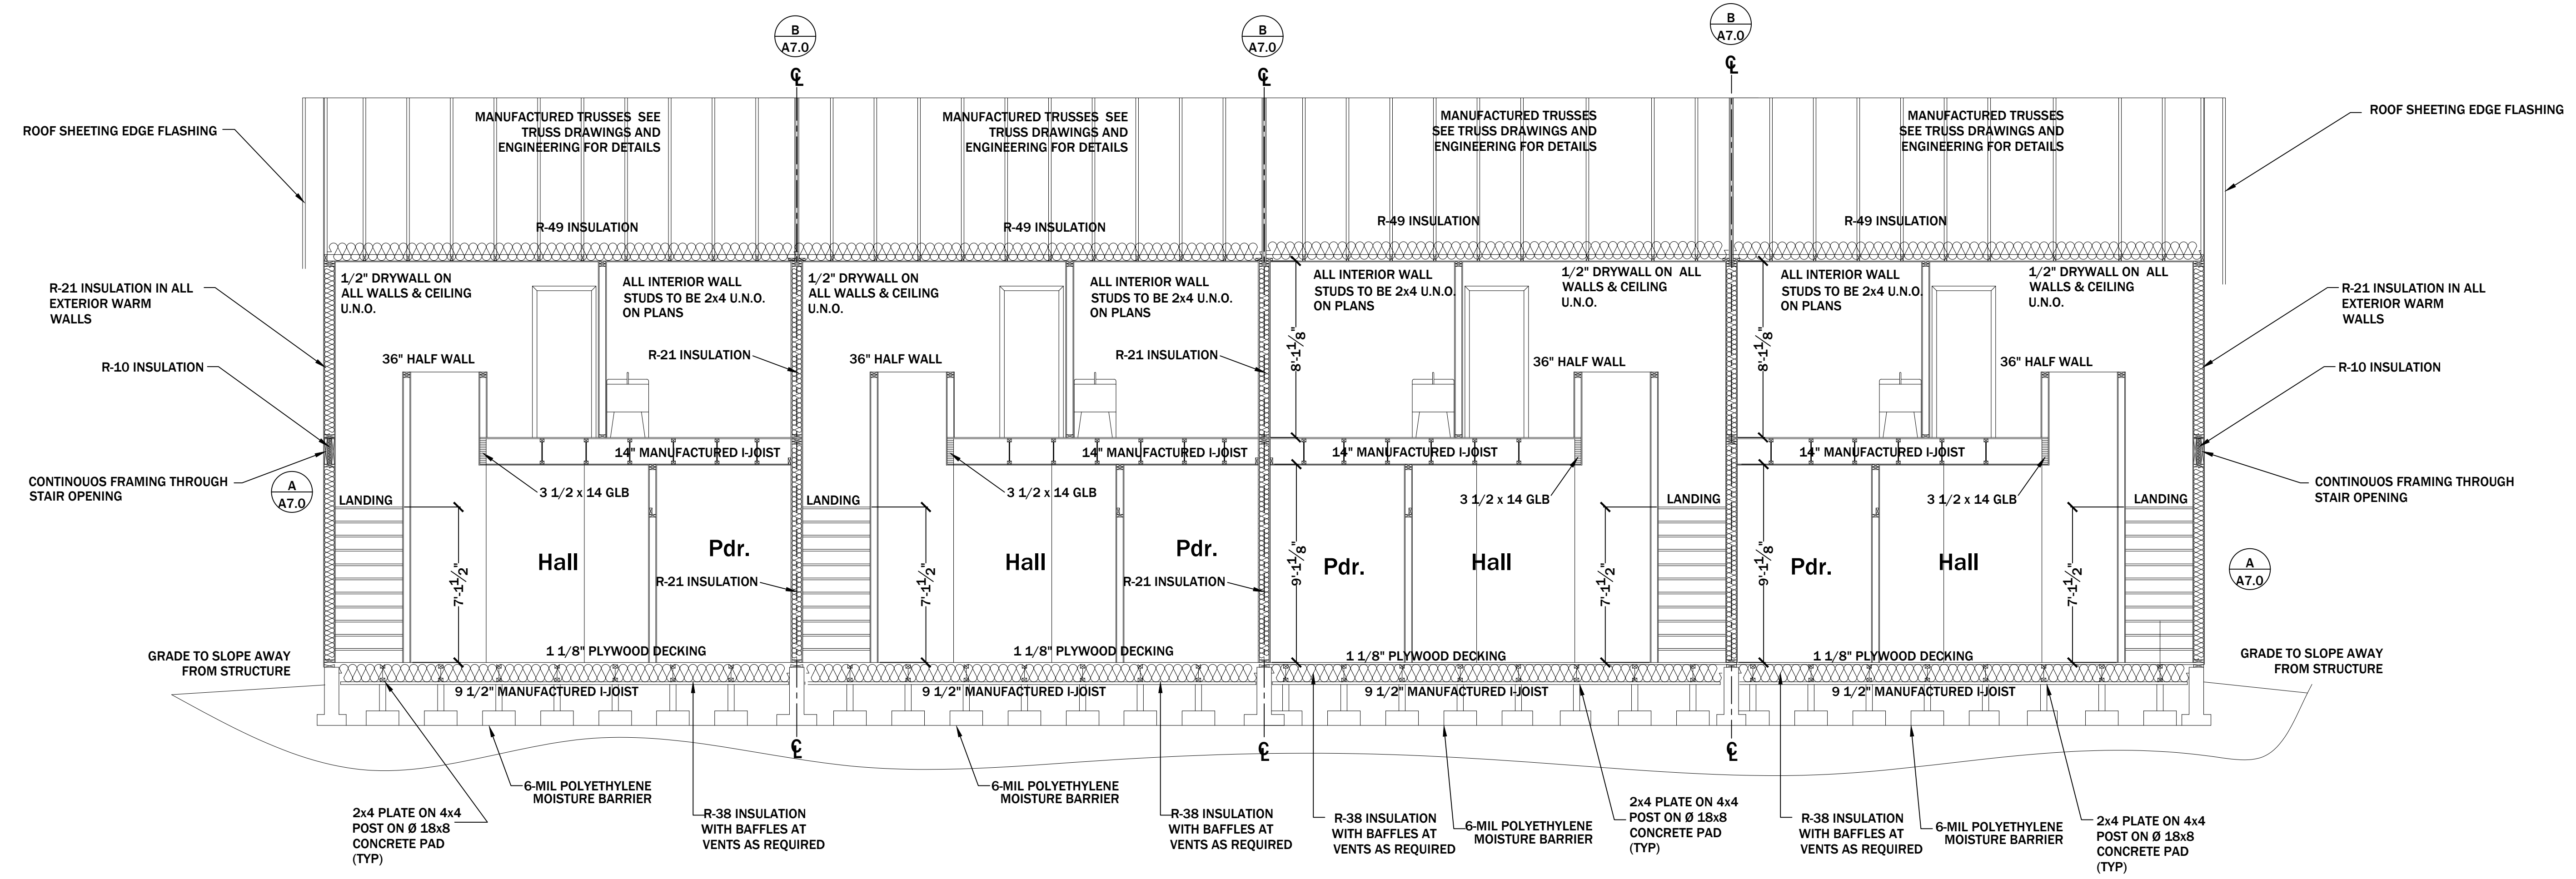
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SECTION DETAIL-A

SCALE: 1/4" = 1'-0"

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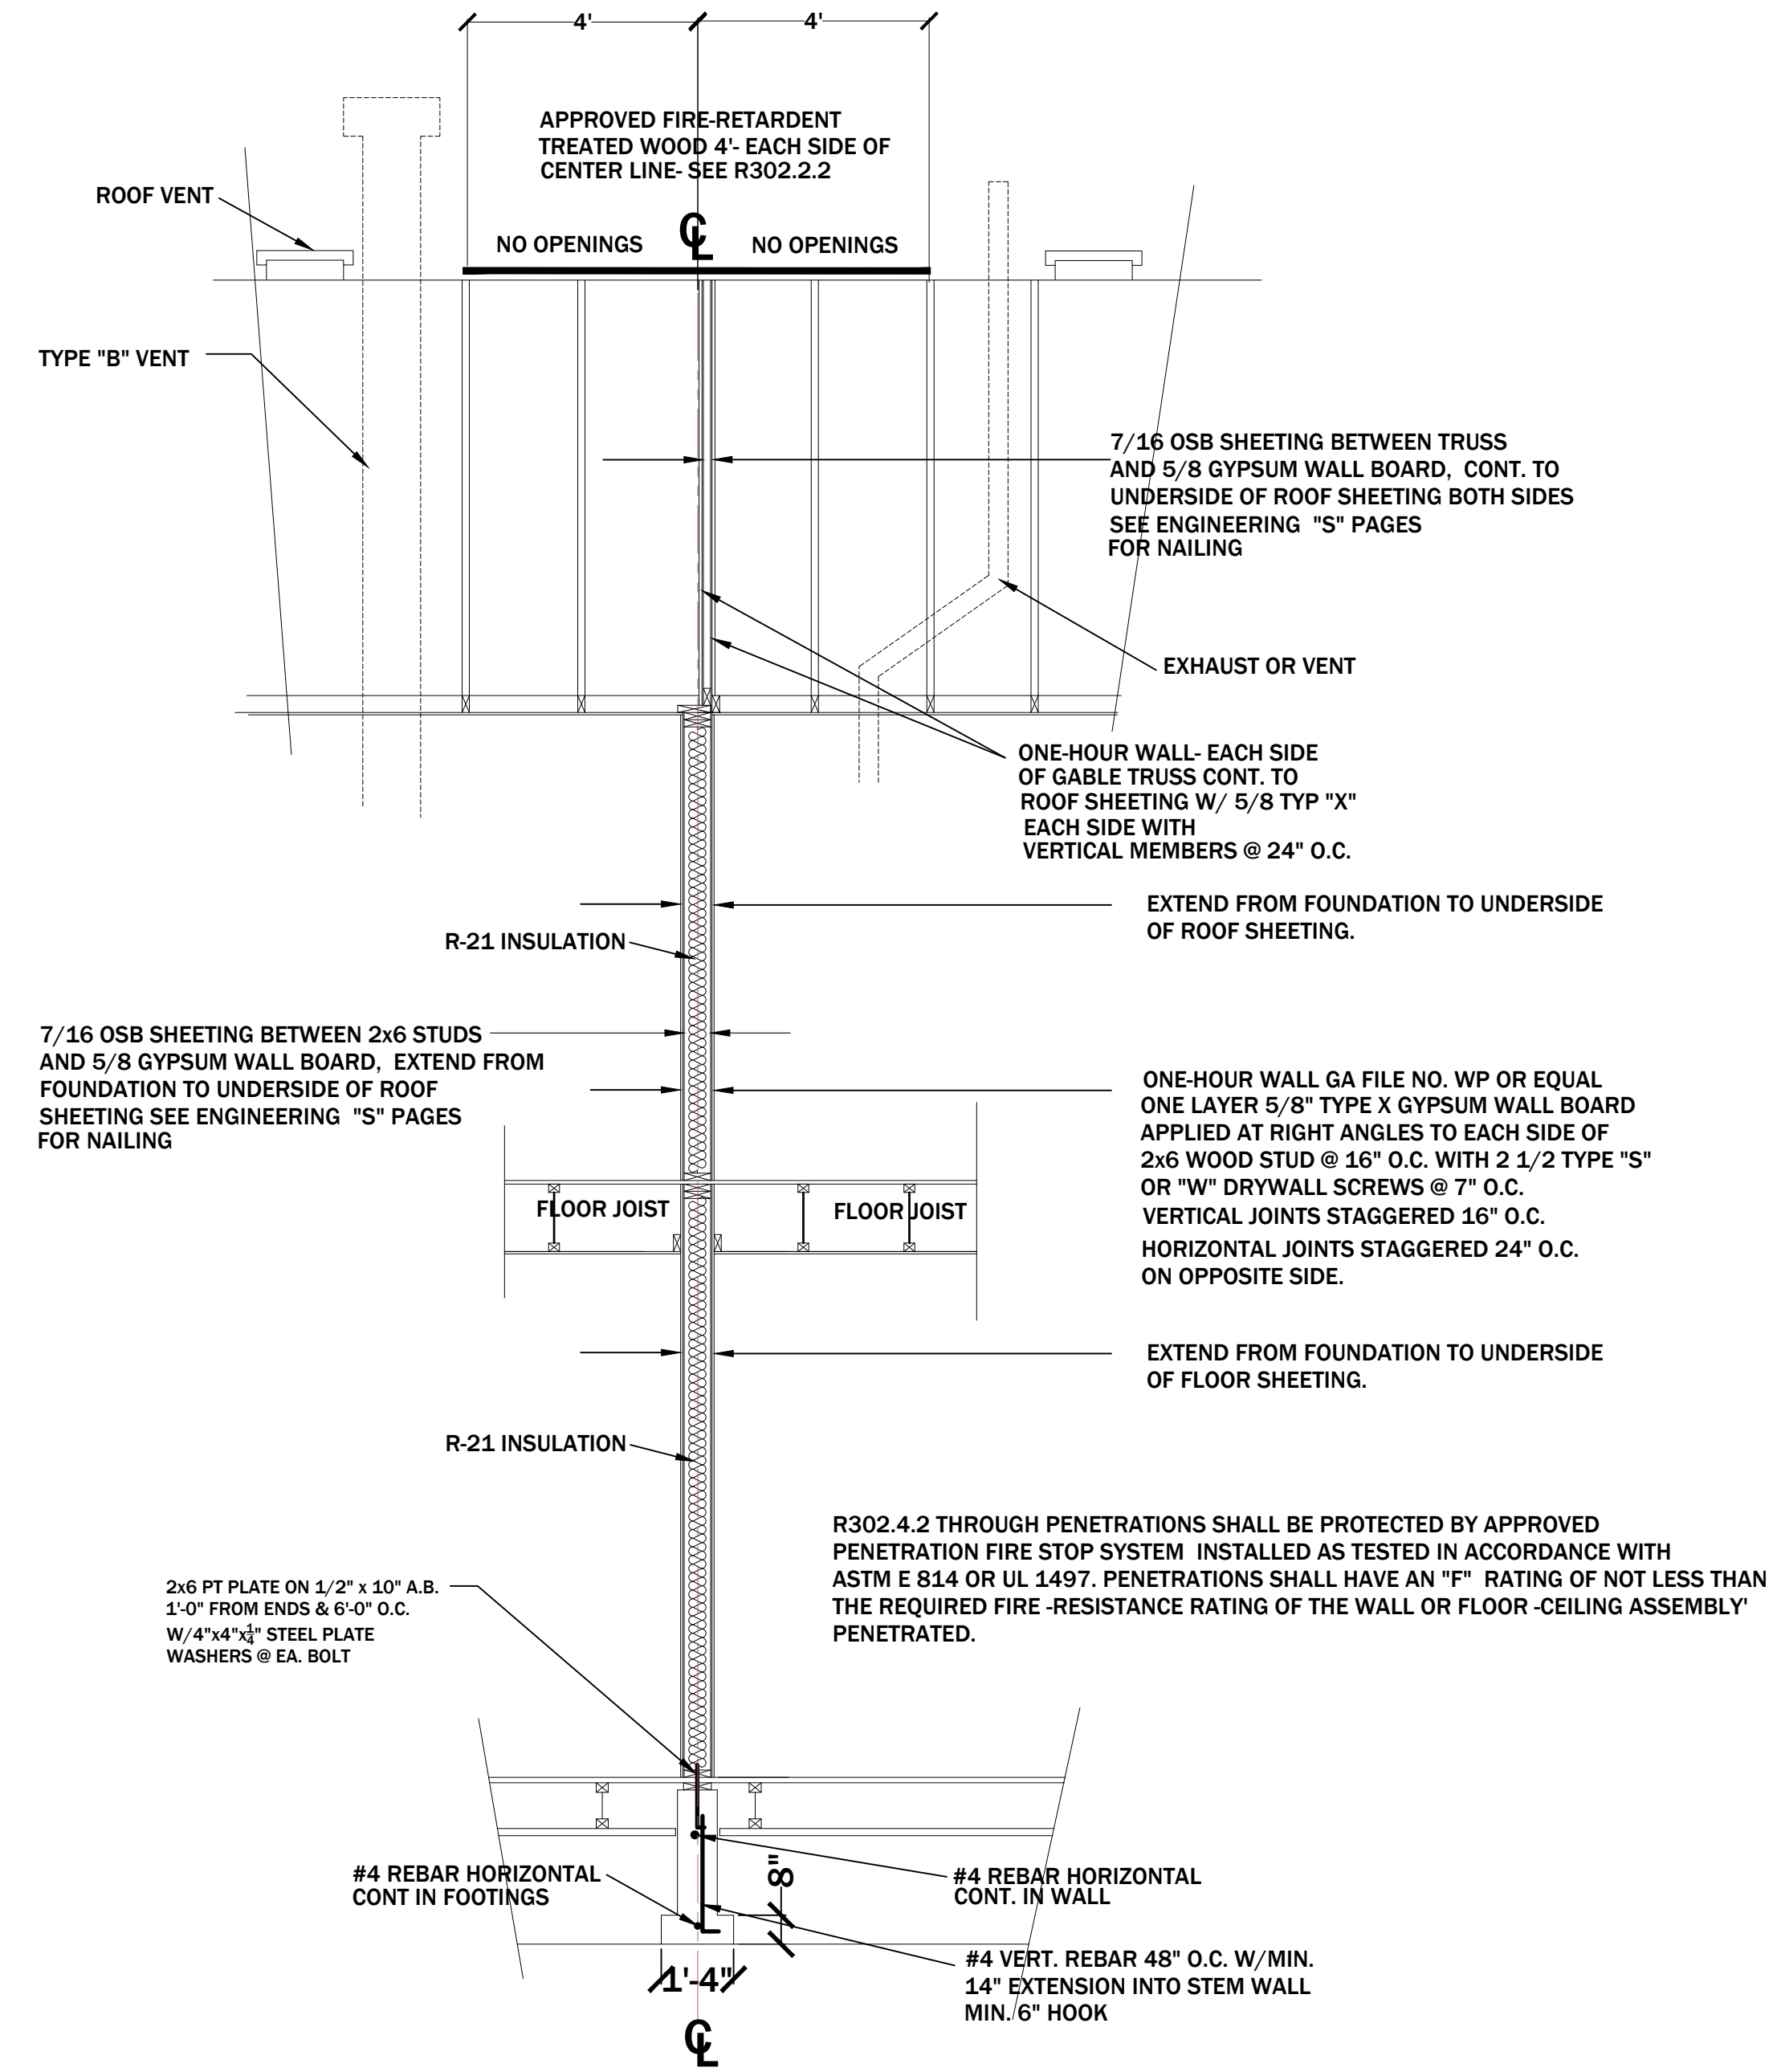
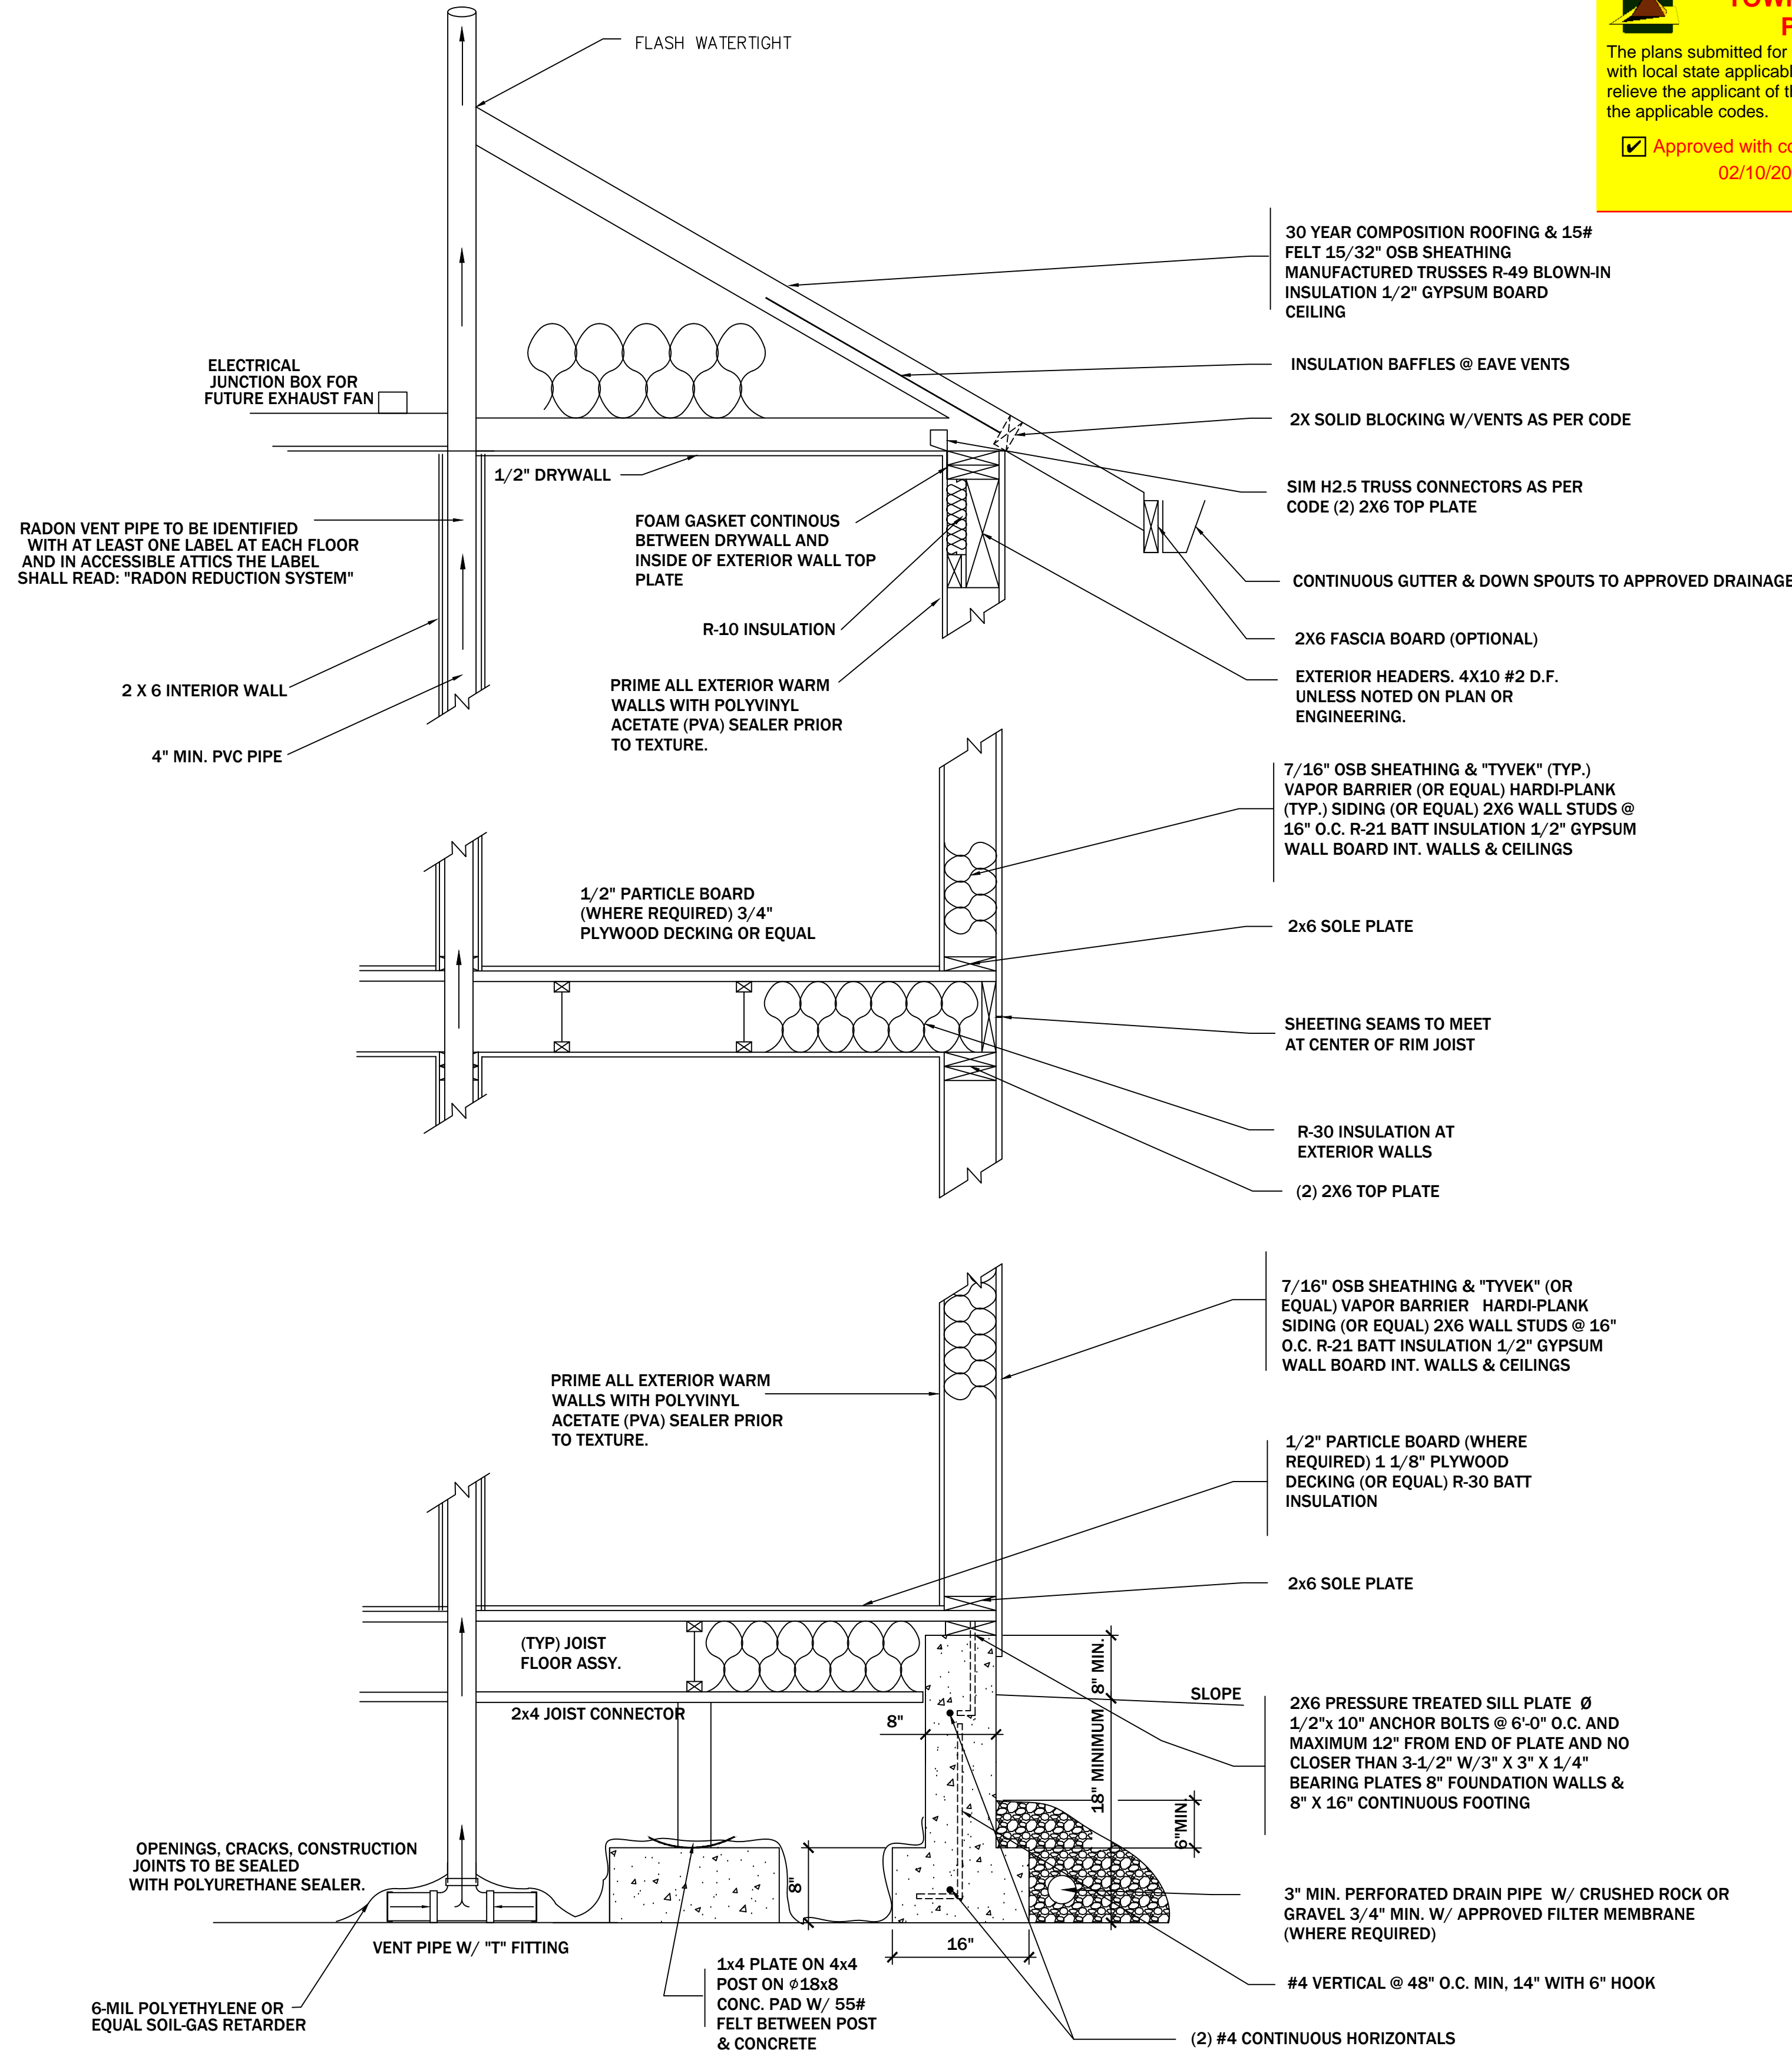
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**TYPICAL WALL SECTION W/
PASSIVE RADON MITIGATION**

A
SCALE: 1" = 1'-0"

TWO STORY HOMES



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INFORMATION:

PLAN NUMBER:
190820

DRAWN FOR:

REVISION	DATE

DWG BY: **N Sampson**

CHK BY:

DATE: **08/20/2019**

FILE NAME: **Lawffer**

SHEET NUMBER



A7.0

**TOWNZEN & ASSOCIATES
PLAN APPROVAL**








The plans submitted for review are approved in accordance with local state applicable standards. This approval does not relieve the applicant of the responsibility of compliance with the applicable codes.

Approved as submitted.
02/10/2020

Konrad Weber

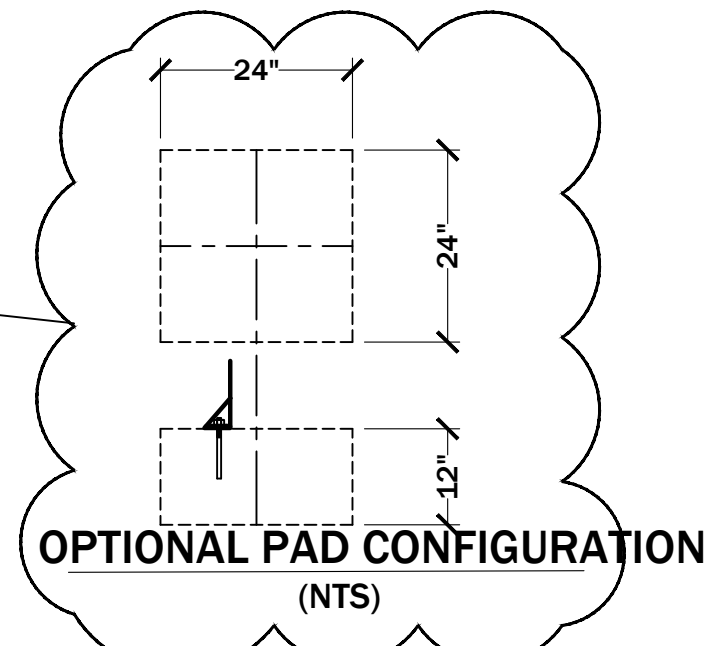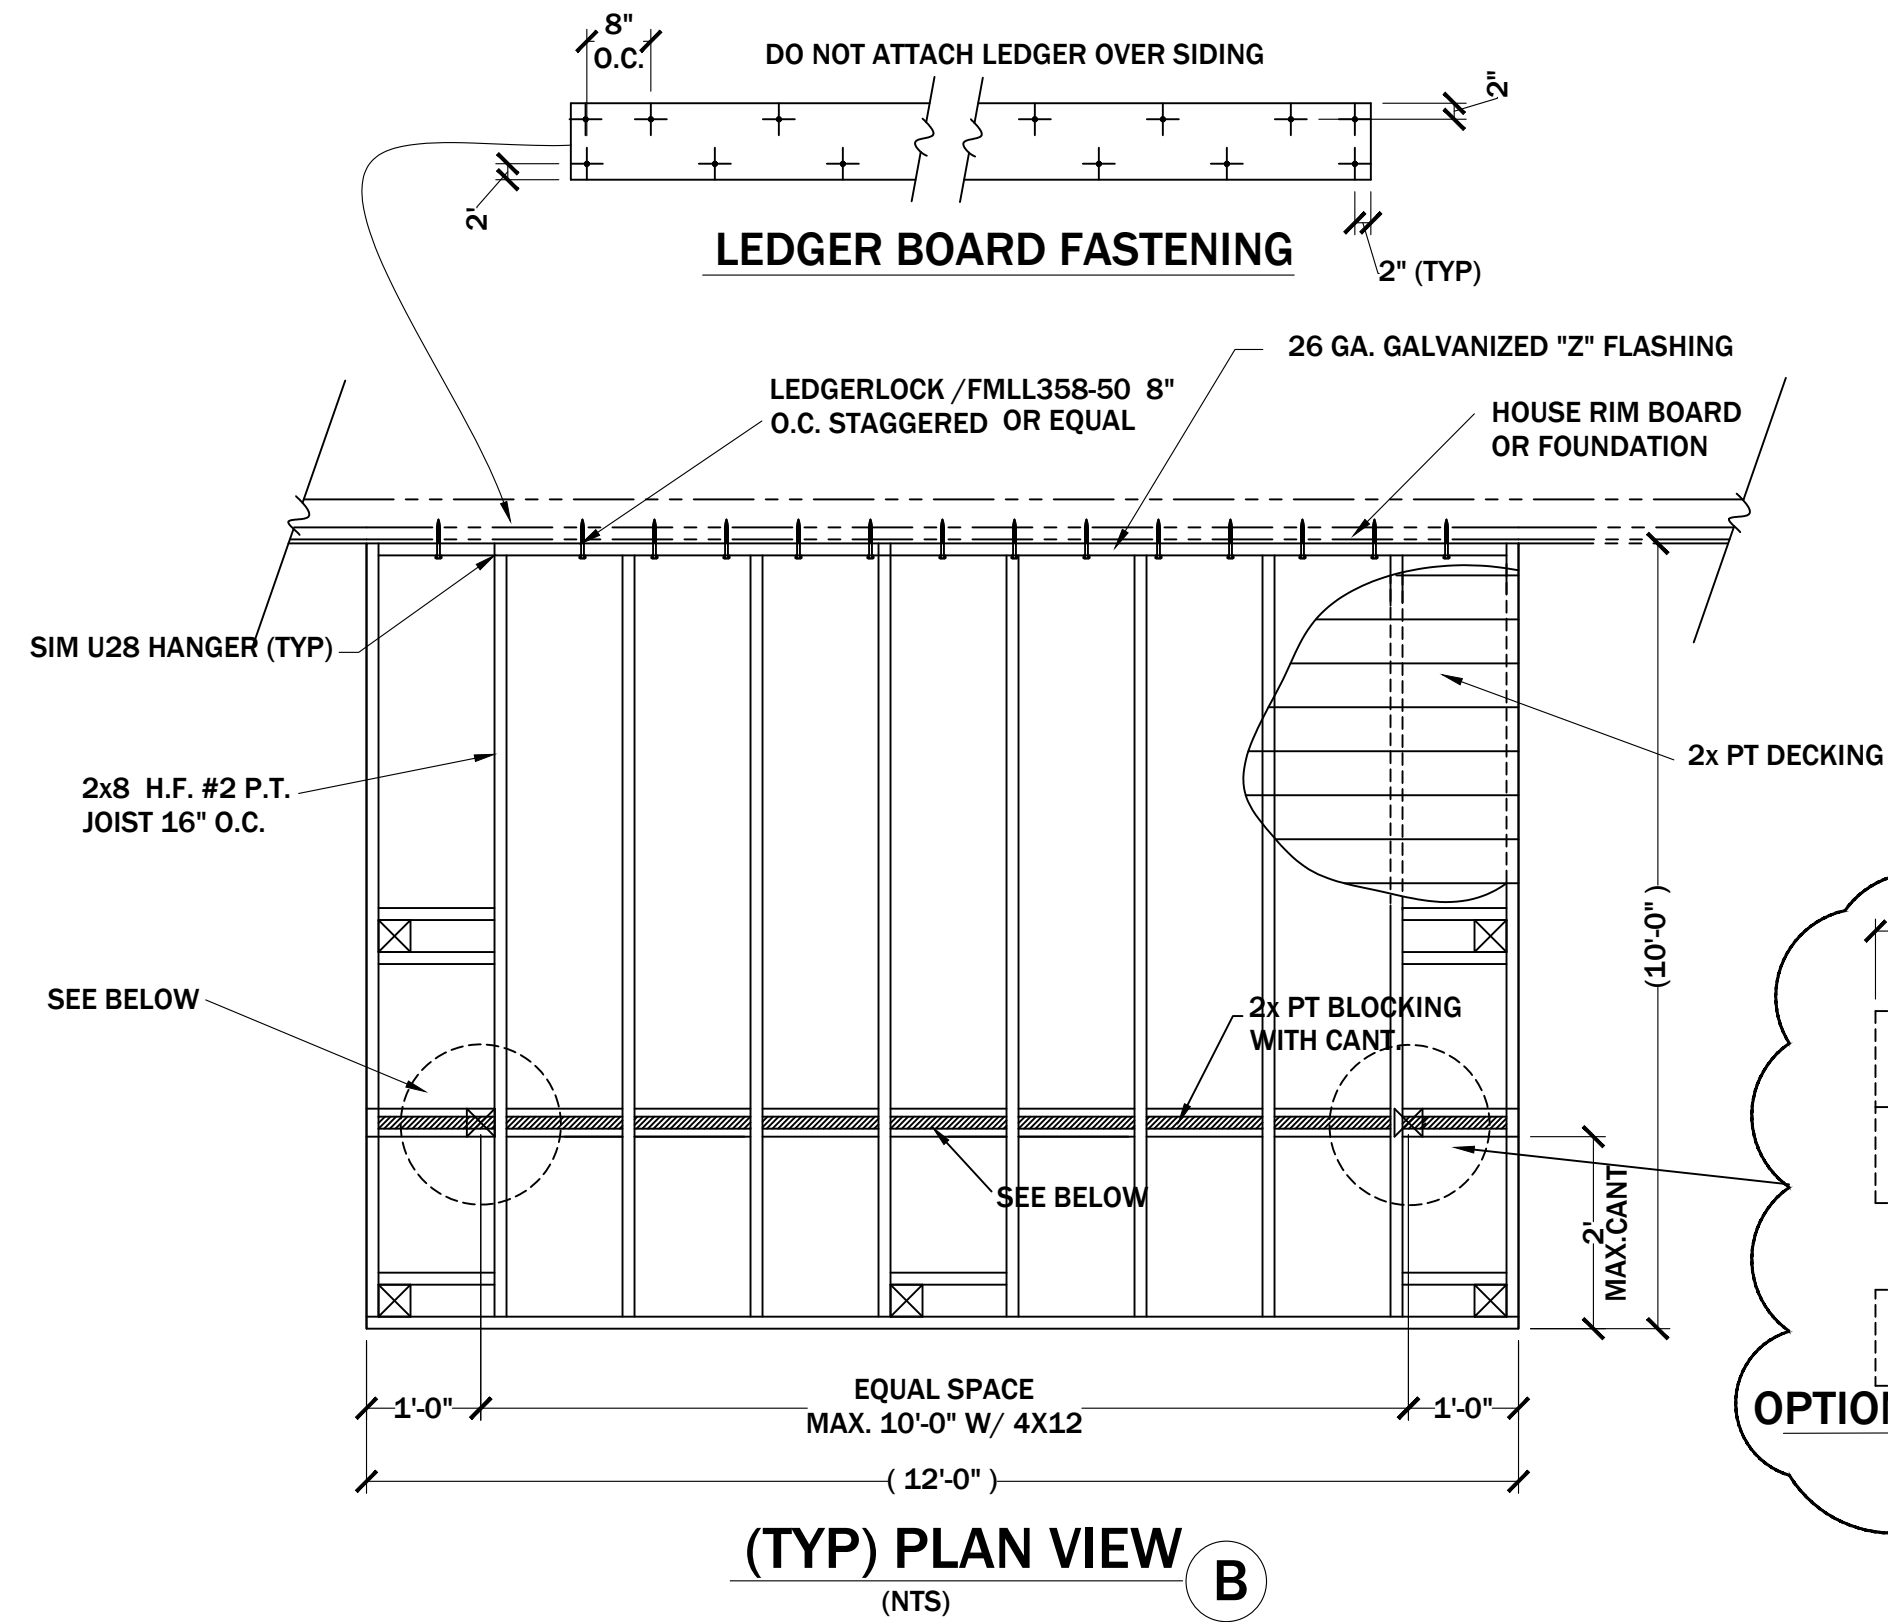

1/2" DIA. THROUGH BOLT AND WASHERS OR EQUAL

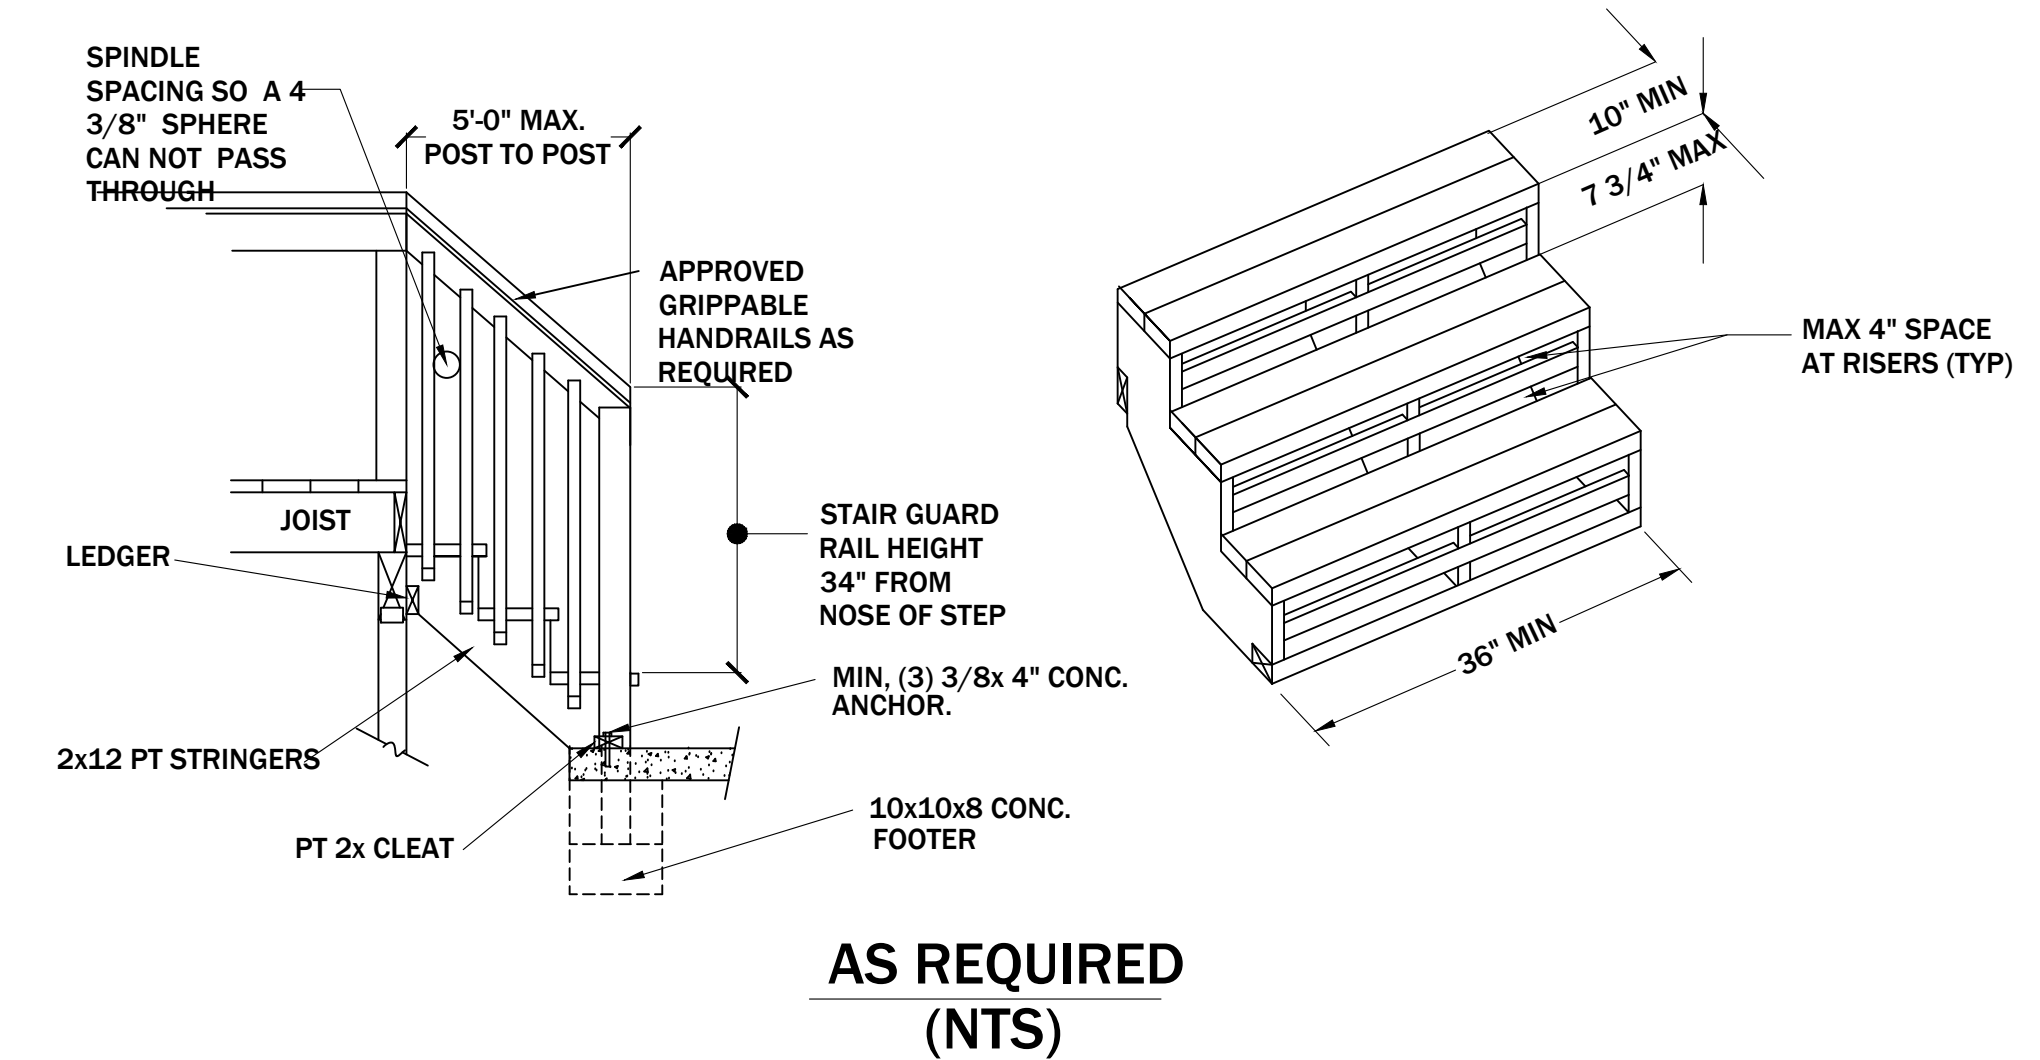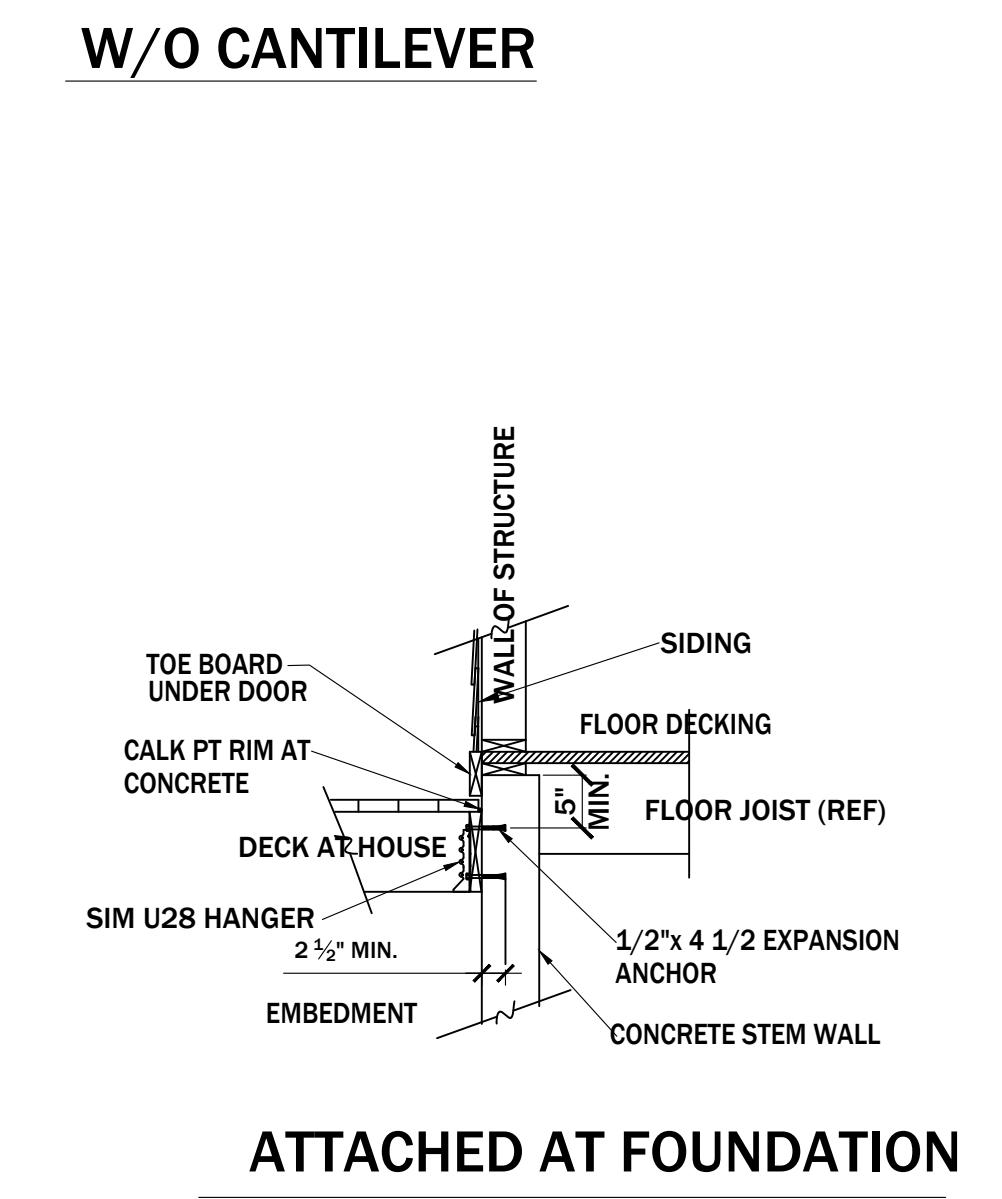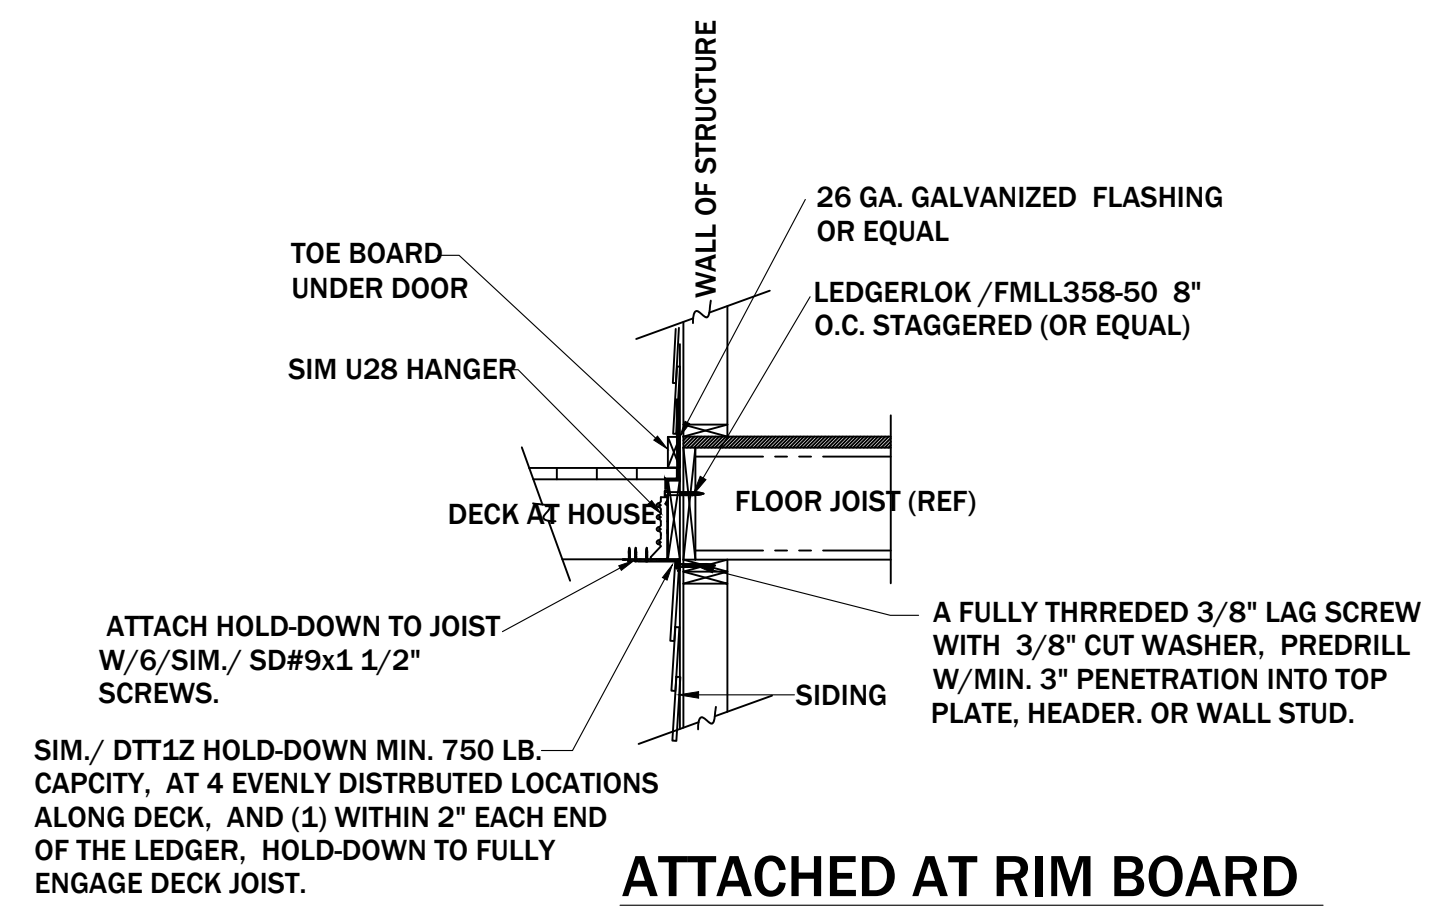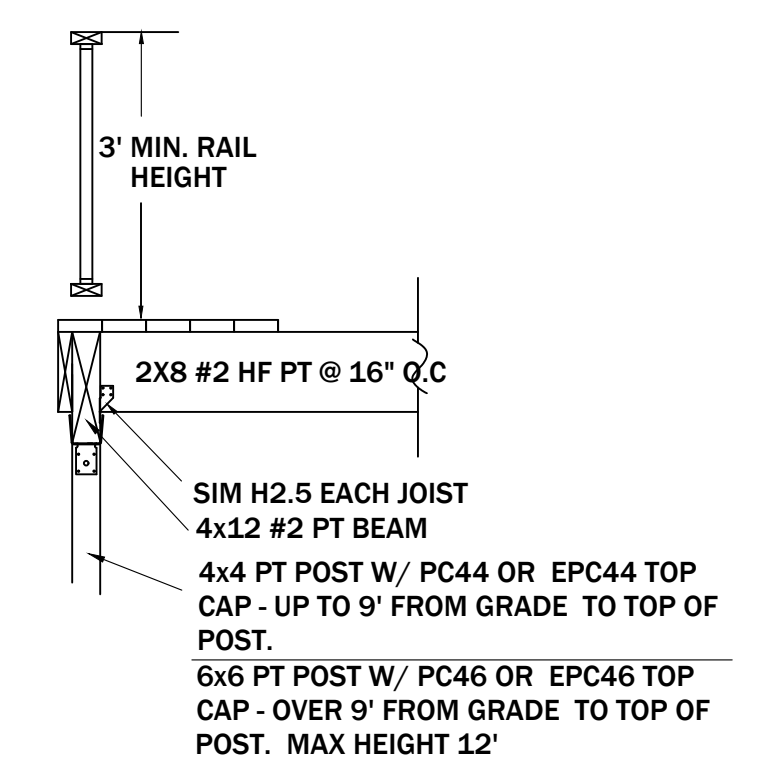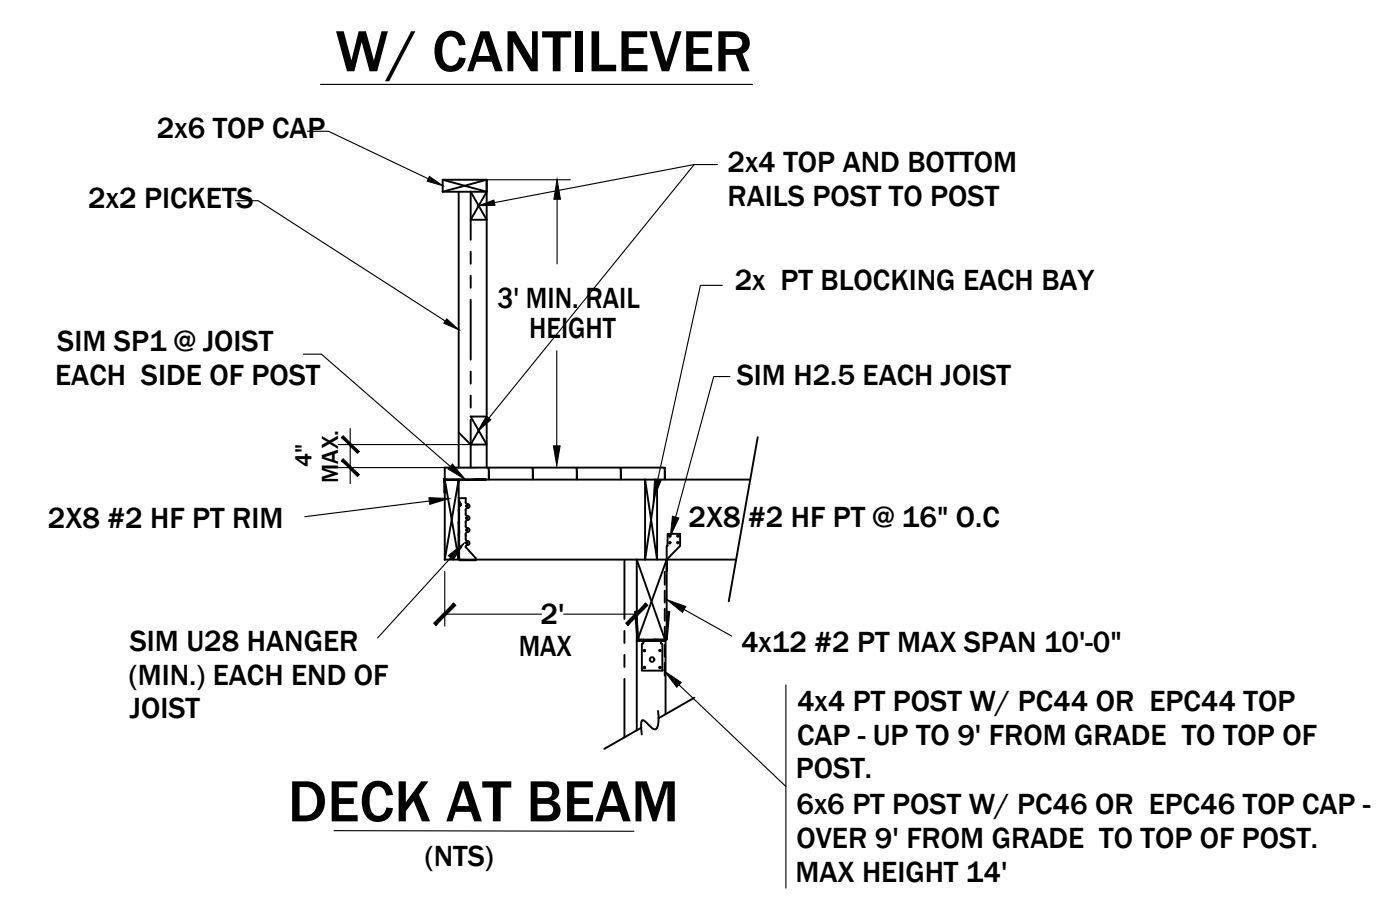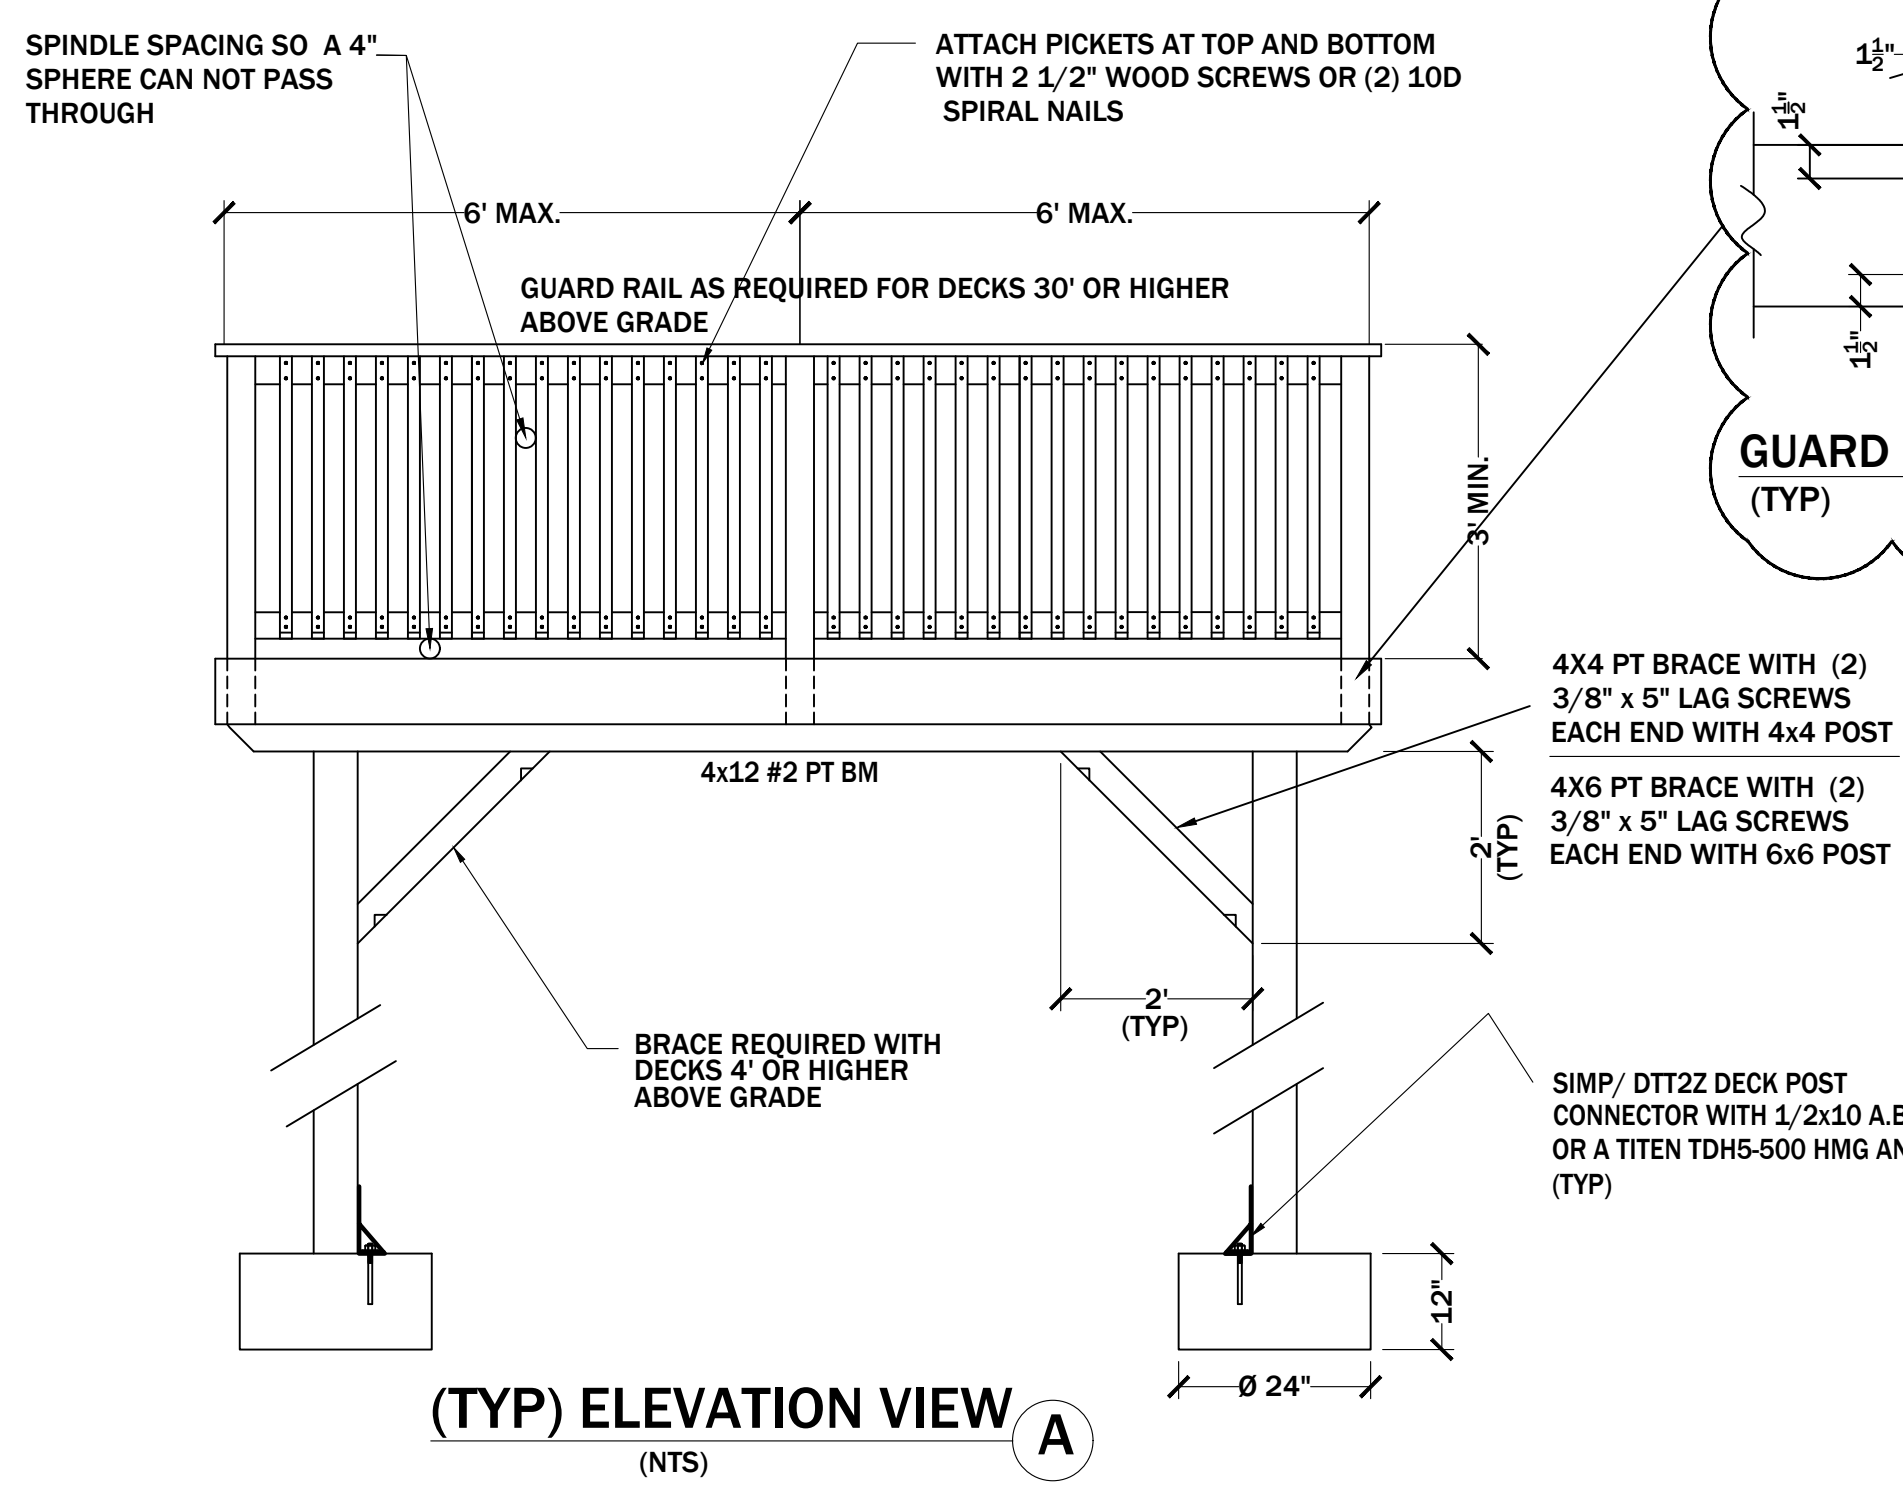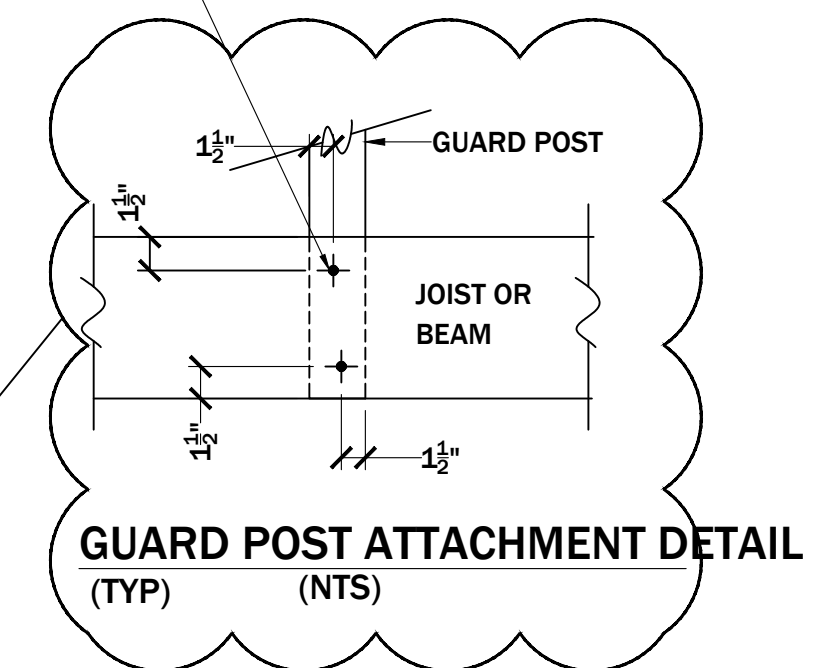

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INFORMATION:

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DRAWN FOR:

REVISION	DATE

DWG BY: **N Sampson**

CHK BY:

DATE: **08/20/2019**

FILE NAME: **Lawffer**

SHEET NUMBER

A7.1

**TOWNZEN & ASSOCIATES
PLAN APPROVAL**

The plans submitted for review are approved in accordance with local state applicable standards. This approval does not relieve the applicant of the responsibility of compliance with the applicable codes.

Approved with comments.
02/10/2020

Konrad Weber
Konrad Weber



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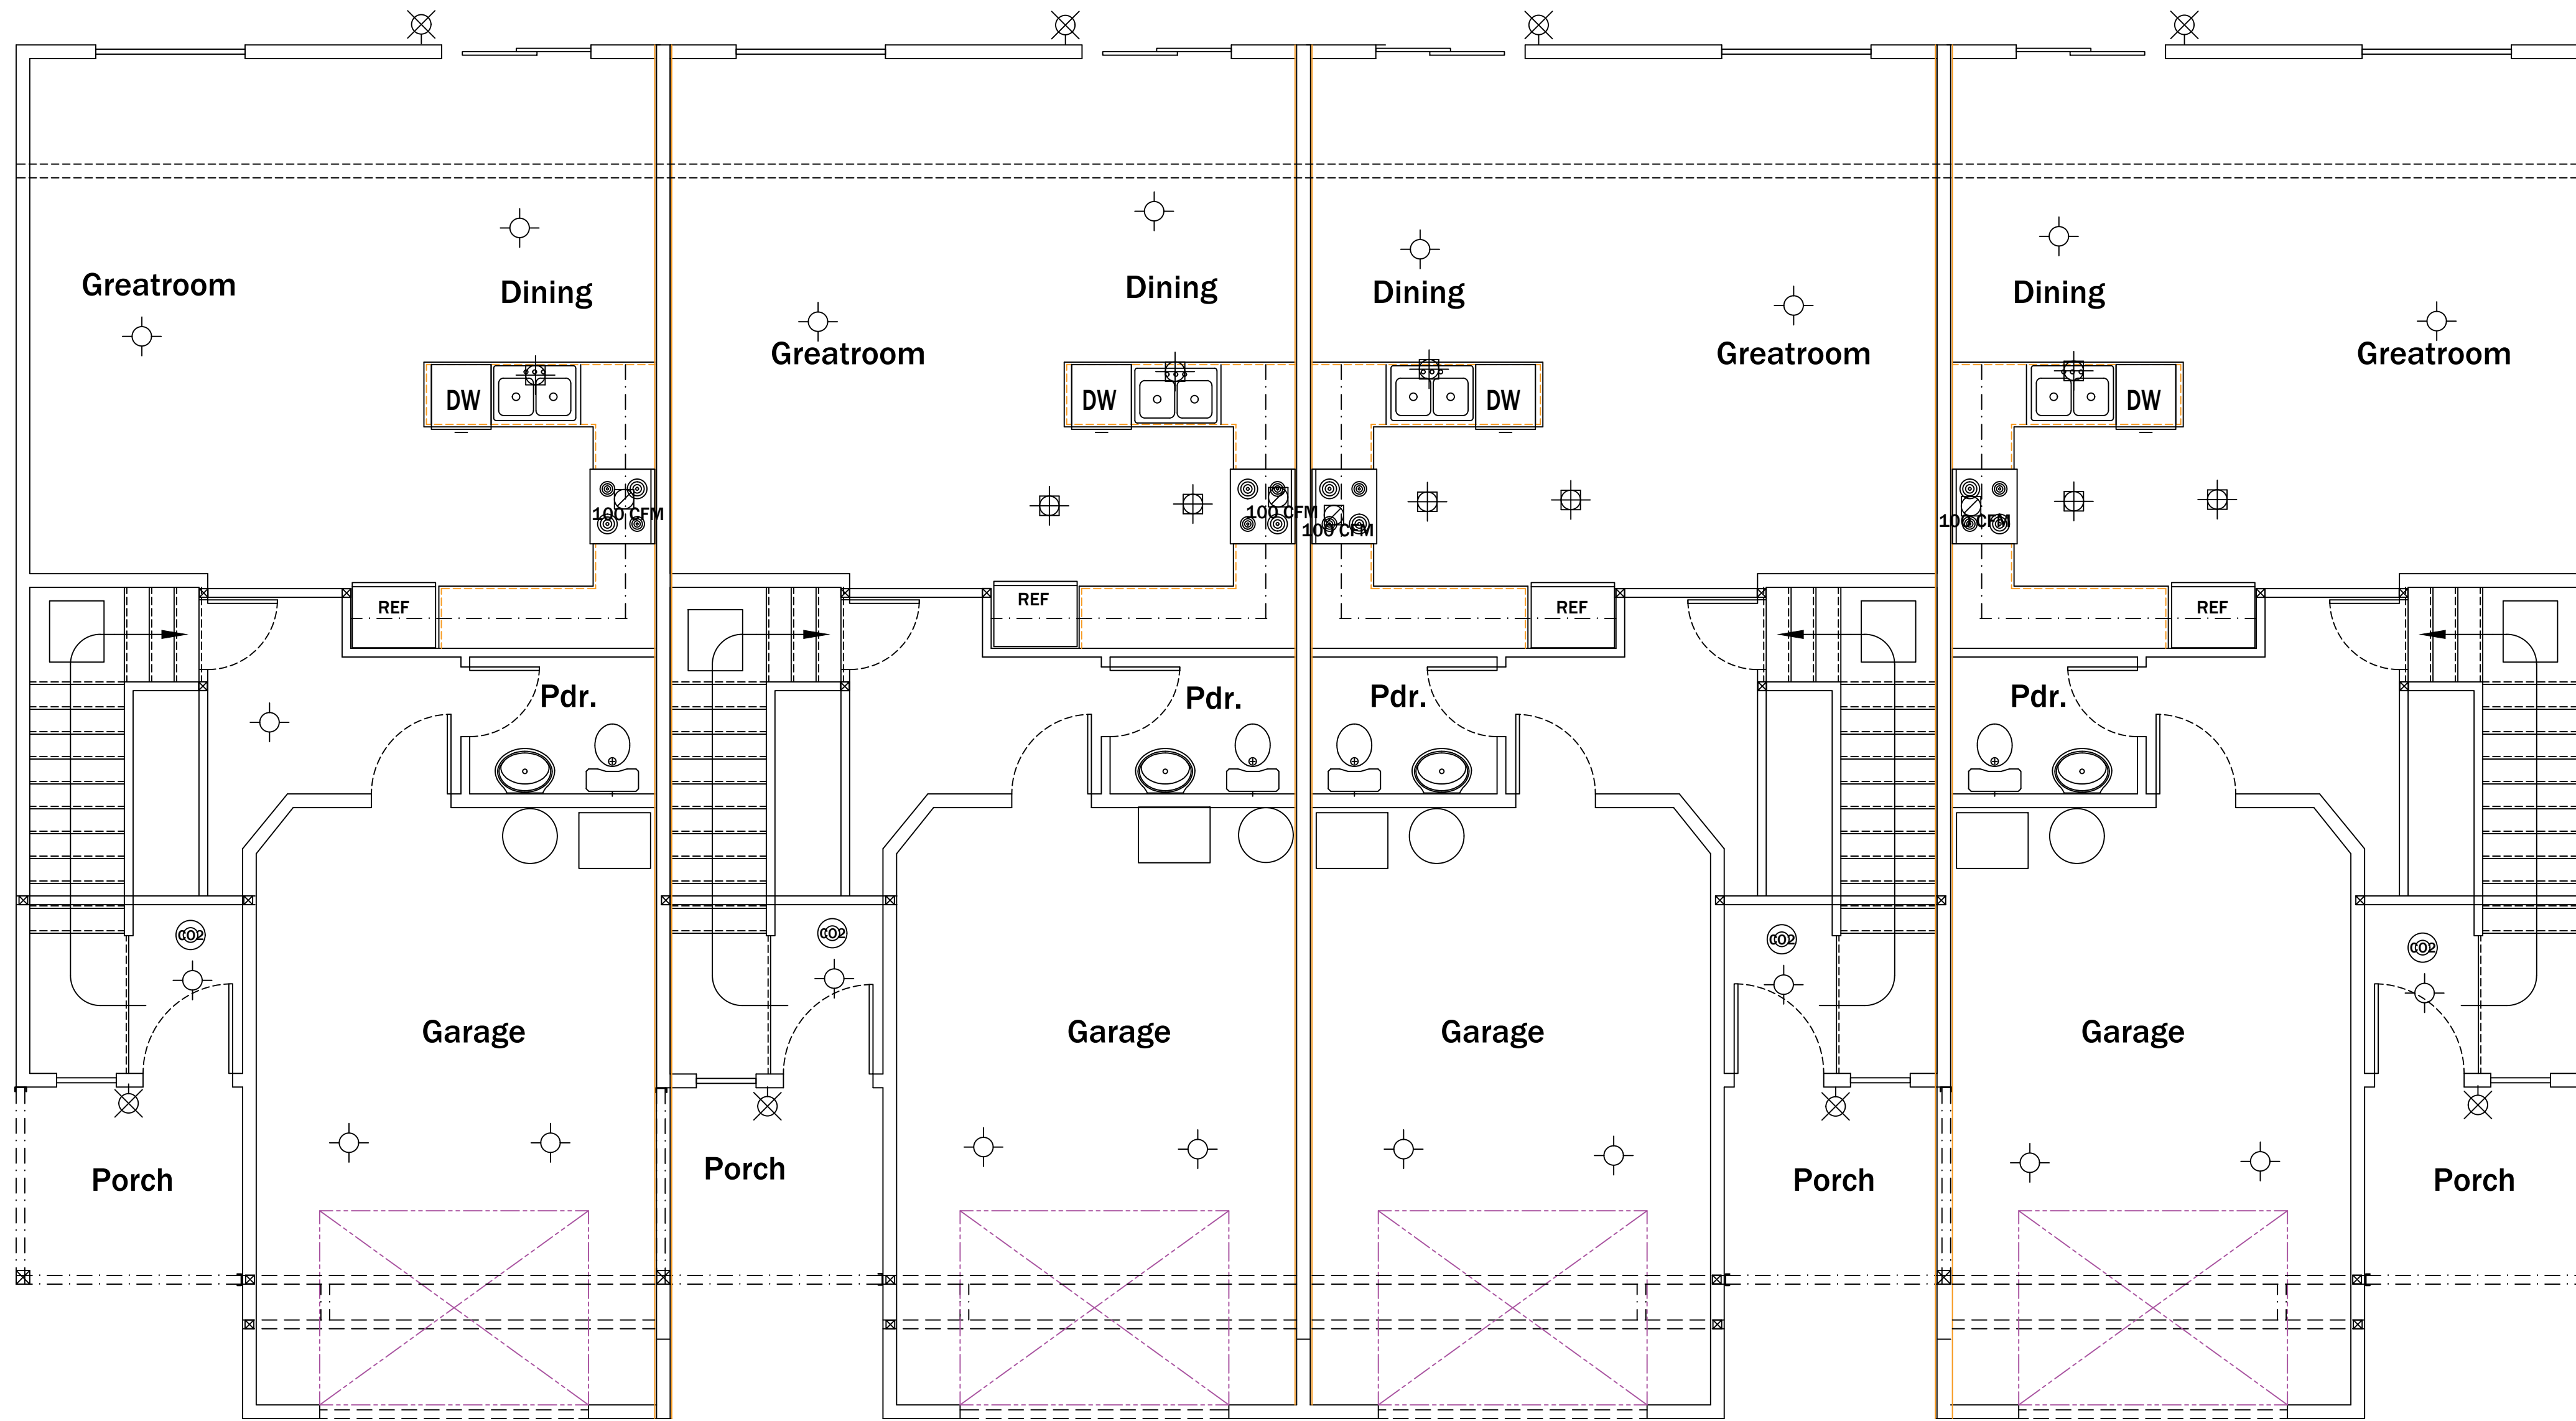
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INFORMATION:

PLAN NUMBER:

190820

DRAWN FOR:



ELECTRICAL LEGEND

- §§§§ SWITCH
- ⊖ RECESSED
- ⊖ RECESSED DIRECTIONAL
- ⊗ WALL MOUNT
- ⊙ CEILING MOUNT
- ⊕ CEILING MOUNT PENDANT
- ⊖ RECESSED EXHAUST FAN VENTED TO OUTSIDE
- ⊖ LITE-FAN COMBINATION
- ⊖ CEILING FAN BOX
- ⊖ DUPLEX OUTLET
- ⊖ 220V OUTLET
- ⊖ BI-POLE CONTROL OUTLET
- WP ⊖ WEATHER-PROOF OUTLET
- ◀ TELEPHONE OUTLET
- ⊖ TELEVISION OUTLET
- ⊙ 110V SMOKE DETECTOR INTERCONNECT WITH ALL DETECTORS IN HOUSE
- ⊙ 110V SMOKE DETECTOR INTERCONNECT WITH ALL DETECTORS IN HOUSE. CO2 COMBINATION
- ⊖ THERMOSTAT
- ==== UNDER COUNTER LIGHTING
- ⊖ DOOR BELL
- ⊖ TRANSFORMER
- ⊖ BELL / BUZZER
- ⊖ SMURF TUBE
- ⊖ 24 HR TIMER ALL HOUSE VENTILATION

WSEC R404.1 LIGHTING EQUIPMENT
A minimum of 75% of permanently installed lamps in fixtures shall be high-efficacy lamps.

REVISION	DATE

DWG BY: **N Sampson**

CHK BY:

DATE: **08/20/2019**

FILE NAME: **Lawffer**

SHEET NUMBER

A8.0



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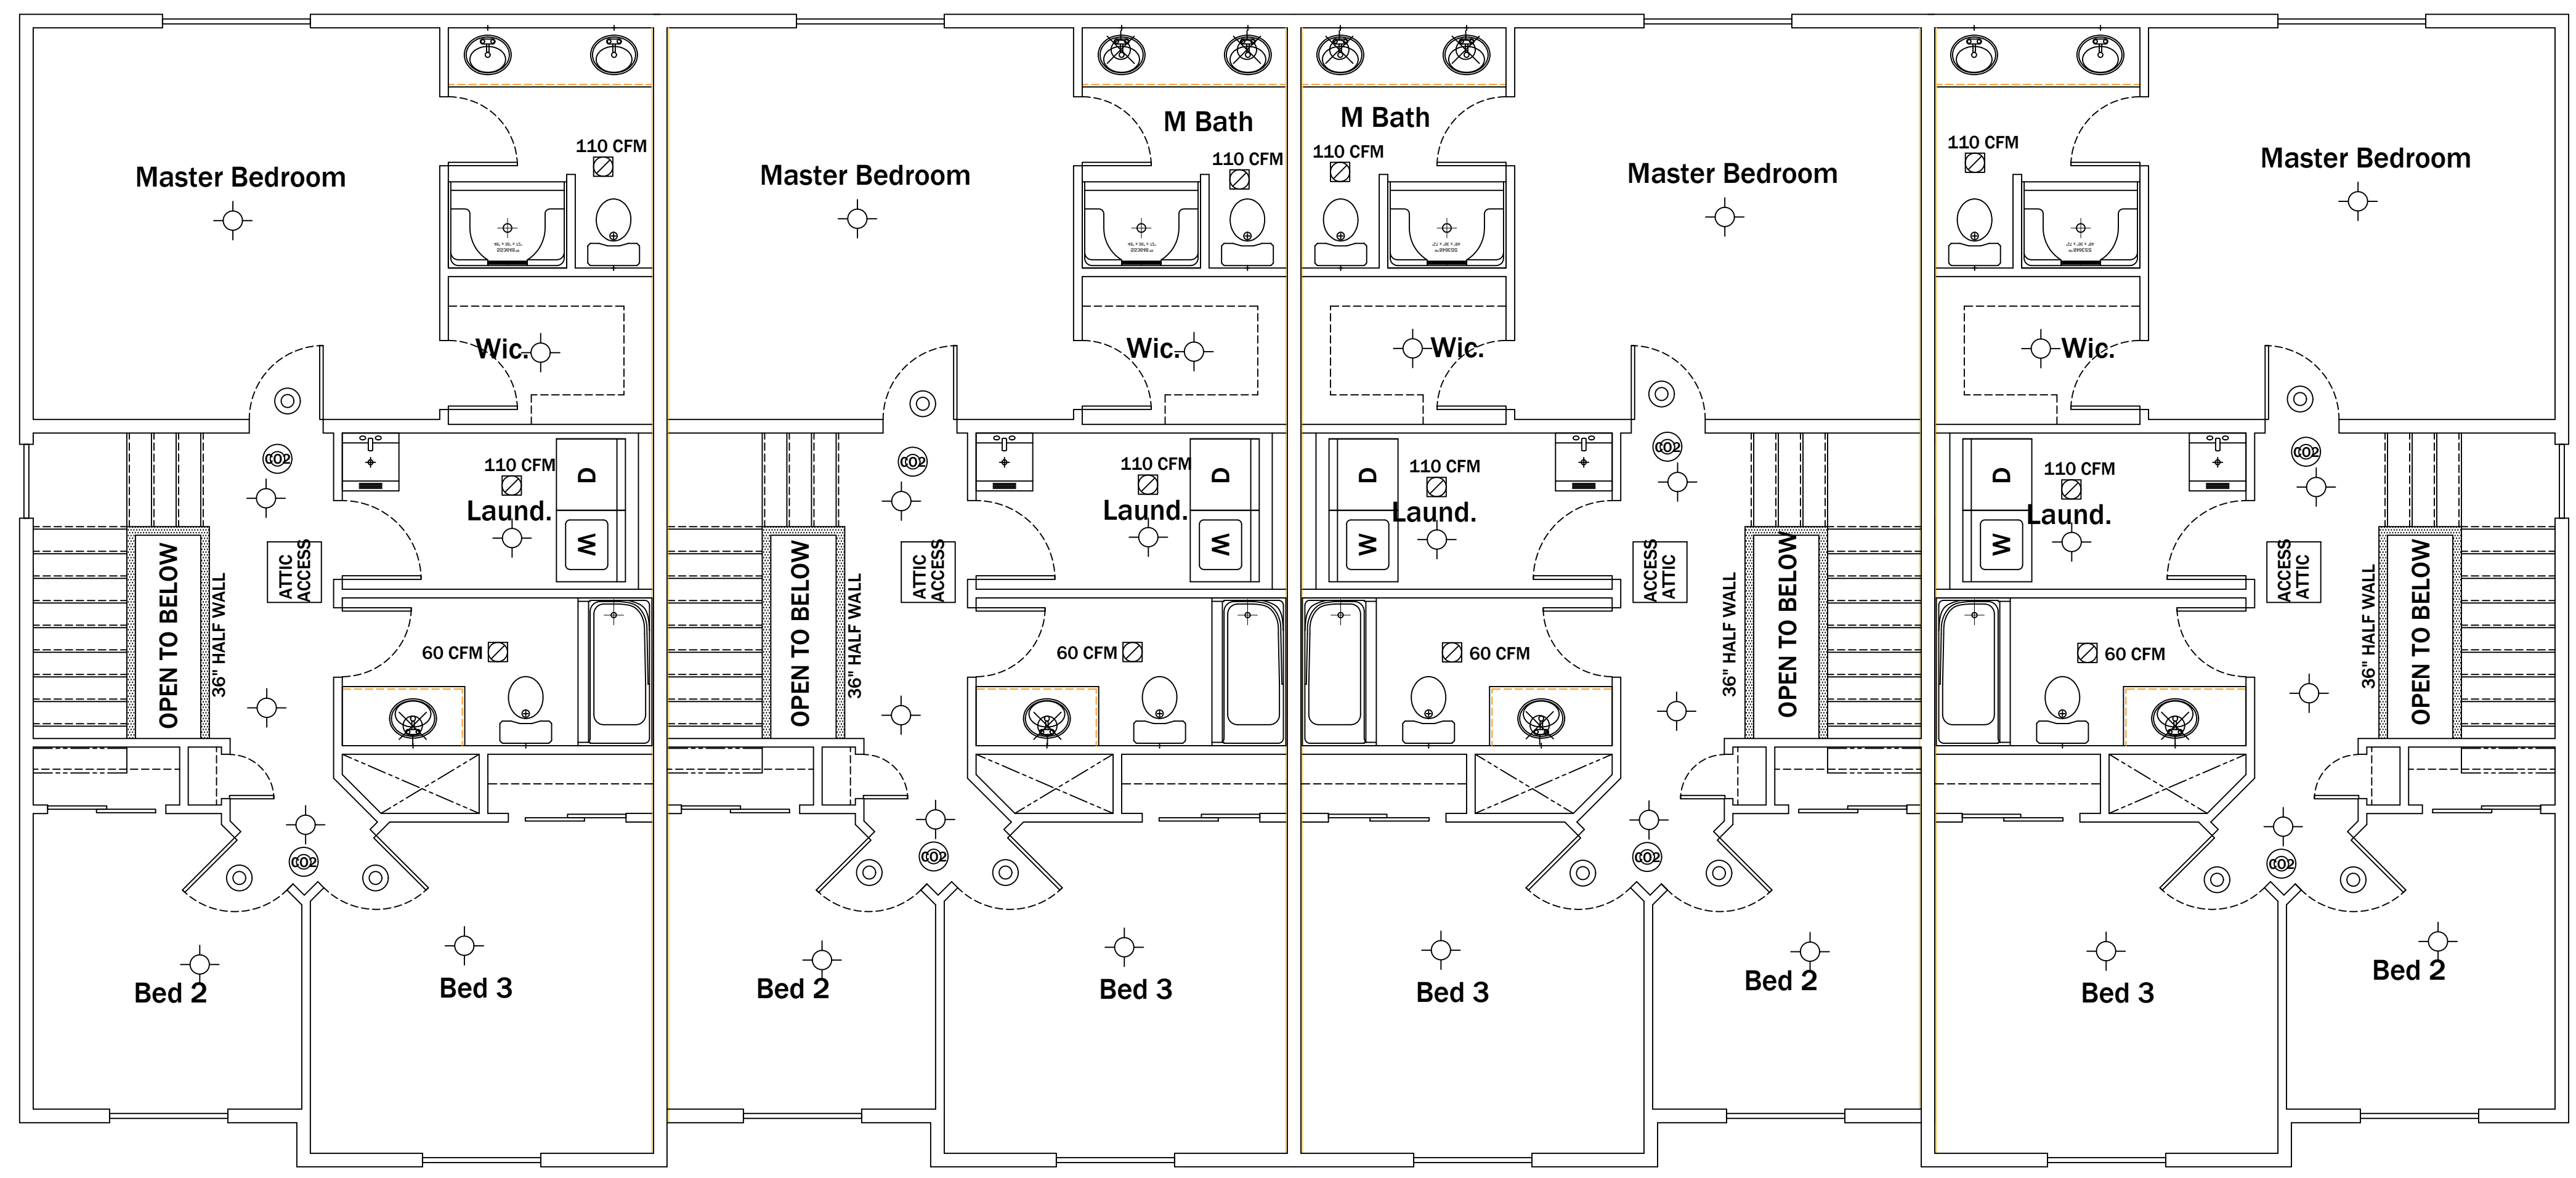
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**TOWNZEN & ASSOCIATES
PLAN APPROVAL**

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Approved with comments.
02/10/2020

Konrad Weber
Konrad Weber



- ELECTRICAL LEGEND**
- \$\$\$ SWITCH
 - ⊖ RECESSED
 - ⊖ RECESSED DIRECTIONAL
 - ⊖ WALL MOUNT
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INFORMATION:

PLAN NUMBER:
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DRAWN FOR:

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